


PROPOSED WAREHOUSE
 2234900 S.F.
 173 EMPLOYEE PARKING STALLS
 44 TRAILER STORAGE STALLS
 57 LOADING DOCKS
 FFE = 485.75
 DOCKS = 481.75

SIGN LEGEND:

- STOP (81-1)
- ACCESSIBLE PARKING (87-8)
- NO PARKING (88-3A)
- STORMWATER SIGNAGE (SW)
- EMERGENCY VEHICLE ACCESS ONLY (88-4)
- DO NOT ENTER (85-1)
- TRUCK ENTRANCE & OFFICE #1 TRAFFIC ONLY (01)
- SIMON & DEWPOINT SOUTH OFFICE #2 TRAFFIC ONLY (02)

| EXISTING | LEGEND | PROPOSED |
|----------|-----------------------------|----------|
| --- | RIGHT OF WAY LINE | --- |
| --- | PROPERTY LINE | --- |
| --- | EDGE OF PAVEMENT | --- |
| --- | CURB | --- |
| --- | DEPRESSED CURB | --- |
| --- | SIDEWALK | --- |
| --- | ROADWAY SIGNS | --- |
| --- | WETLAND LINE | --- |
| --- | STALL COUNT | 10 |
| --- | ADA ACCESSIBLE STALL | ♿ |
| --- | DEPRESSED CURB AND ADA RAMP | HC |
| --- | DIRECTION OF TRAFFIC FLOW | → |

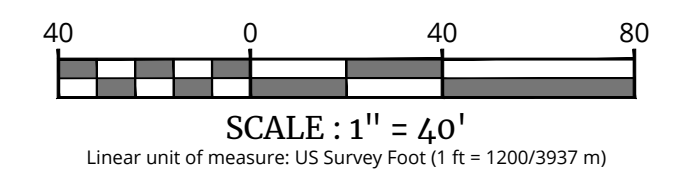

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Cory D. Robinson
 Cory Daniel Robinson
 NEW YORK LICENSED PROFESSIONAL ENGINEER
 LICENSE NUMBER: 103788
 COLLIER ENGINEERING & DESIGN CT, P.C.
 N.Y. C.O.A.#: 0017609

PRELIMINARY SITE PLAN
 FOR
DEWPOINT SOUTH
 SBL: 4-1-50.32, 6-1-90.22,
 90.24 & 107
 TOWN OF WAWAYANDA
 ORANGE COUNTY
 NEW YORK STATE

Colliers
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 Phone: 845.564.4495
 COLLIER ENGINEERING & DESIGN
 ARCHITECTURAL, LANDSCAPE ARCHITECTURE,
 SURVEYING, C.T.P.C.

SCALE: AS SHOWN
 DATE: 04/08/2024
 PROJECT NUMBER: 20006912E
 DRAWING NAME: C-LAY1
 DRAWN BY: MAS
 CHECKED BY: CDR

SHEET TITLE:
DIMENSION PLAN
 WEST

SHEET NUMBER:
C-301



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NOTE: DO NOT SCALE DRAWINGS FOR CONSTRUCTION.



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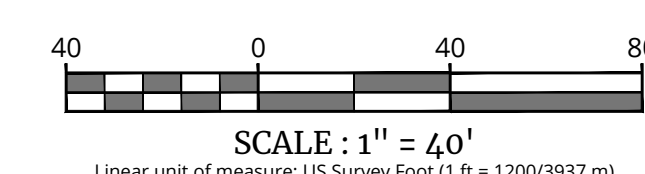
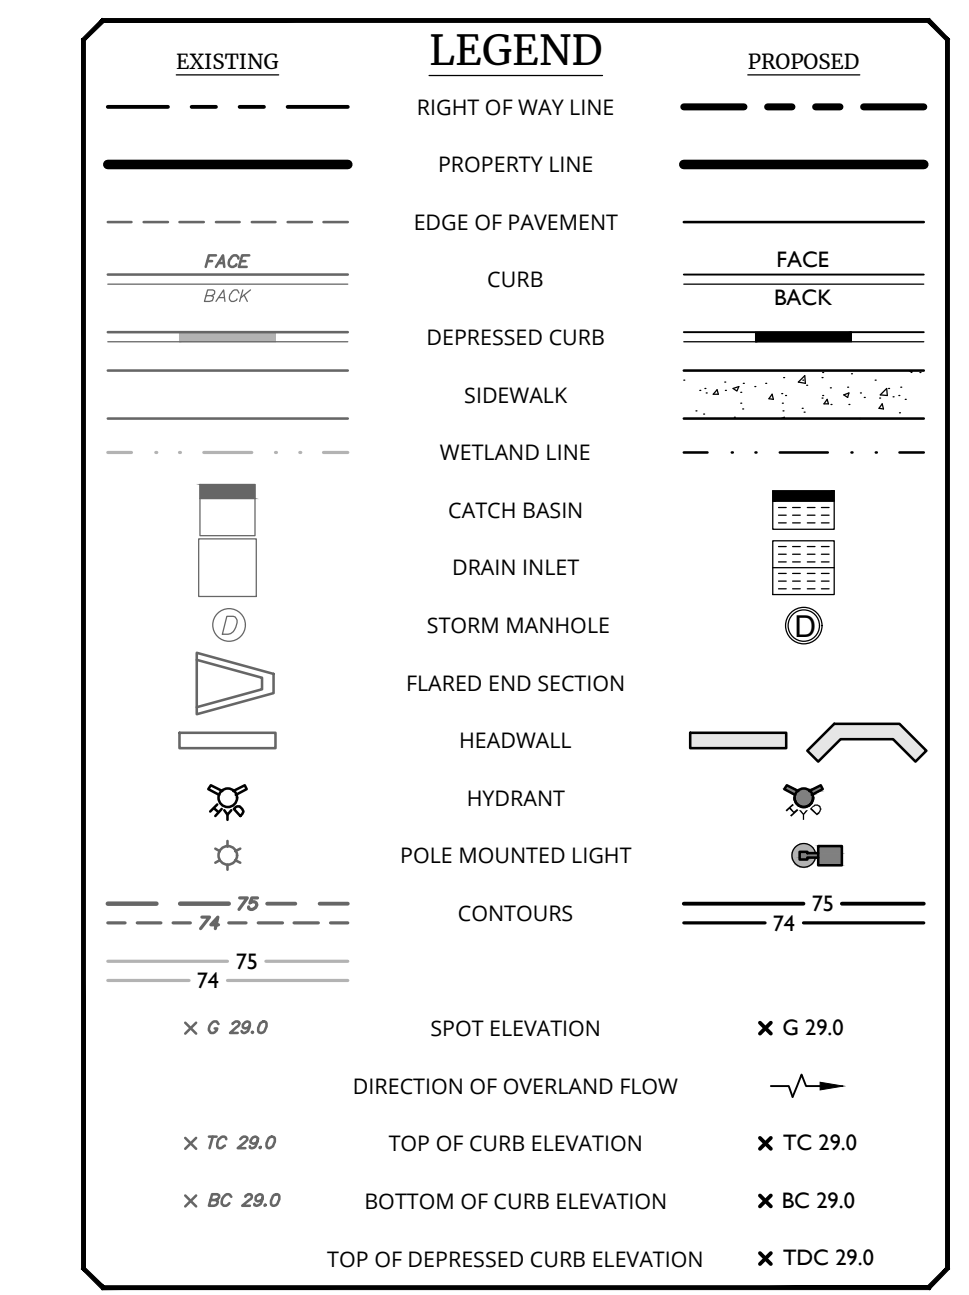
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| EARTHWORK | |
|---------------------------------|---------------|
| CUT | 51,329 CY |
| FILL | 60,226 CY |
| APPROXIMATE IMPERVIOUS AREA CUT | 25,446 CY |
| NET CUT/FILL | 16,549 CY CUT |

NOTES:

1. EARTHWORK CALCULATIONS PROVIDED ARE PRELIMINARY FOR ESTIMATING PURPOSES ONLY. THE CONTRACTOR IS RESPONSIBLE FOR CALCULATING FINAL EARTHWORK VOLUMES PRIOR TO BID AND CONSTRUCTION. PRELIMINARY ESTIMATES ACCOUNT FOR SURFACE TO SURFACE VOLUMES, WITH AN ESTIMATE FOR PAVEMENT AND SUBBASE DEPTHS. NO EXPANSION FACTORS, TOPSOIL, OR UTILITY TRENCH/WALL BACKFILL VOLUMES ARE INCLUDED IN THIS ESTIMATE.

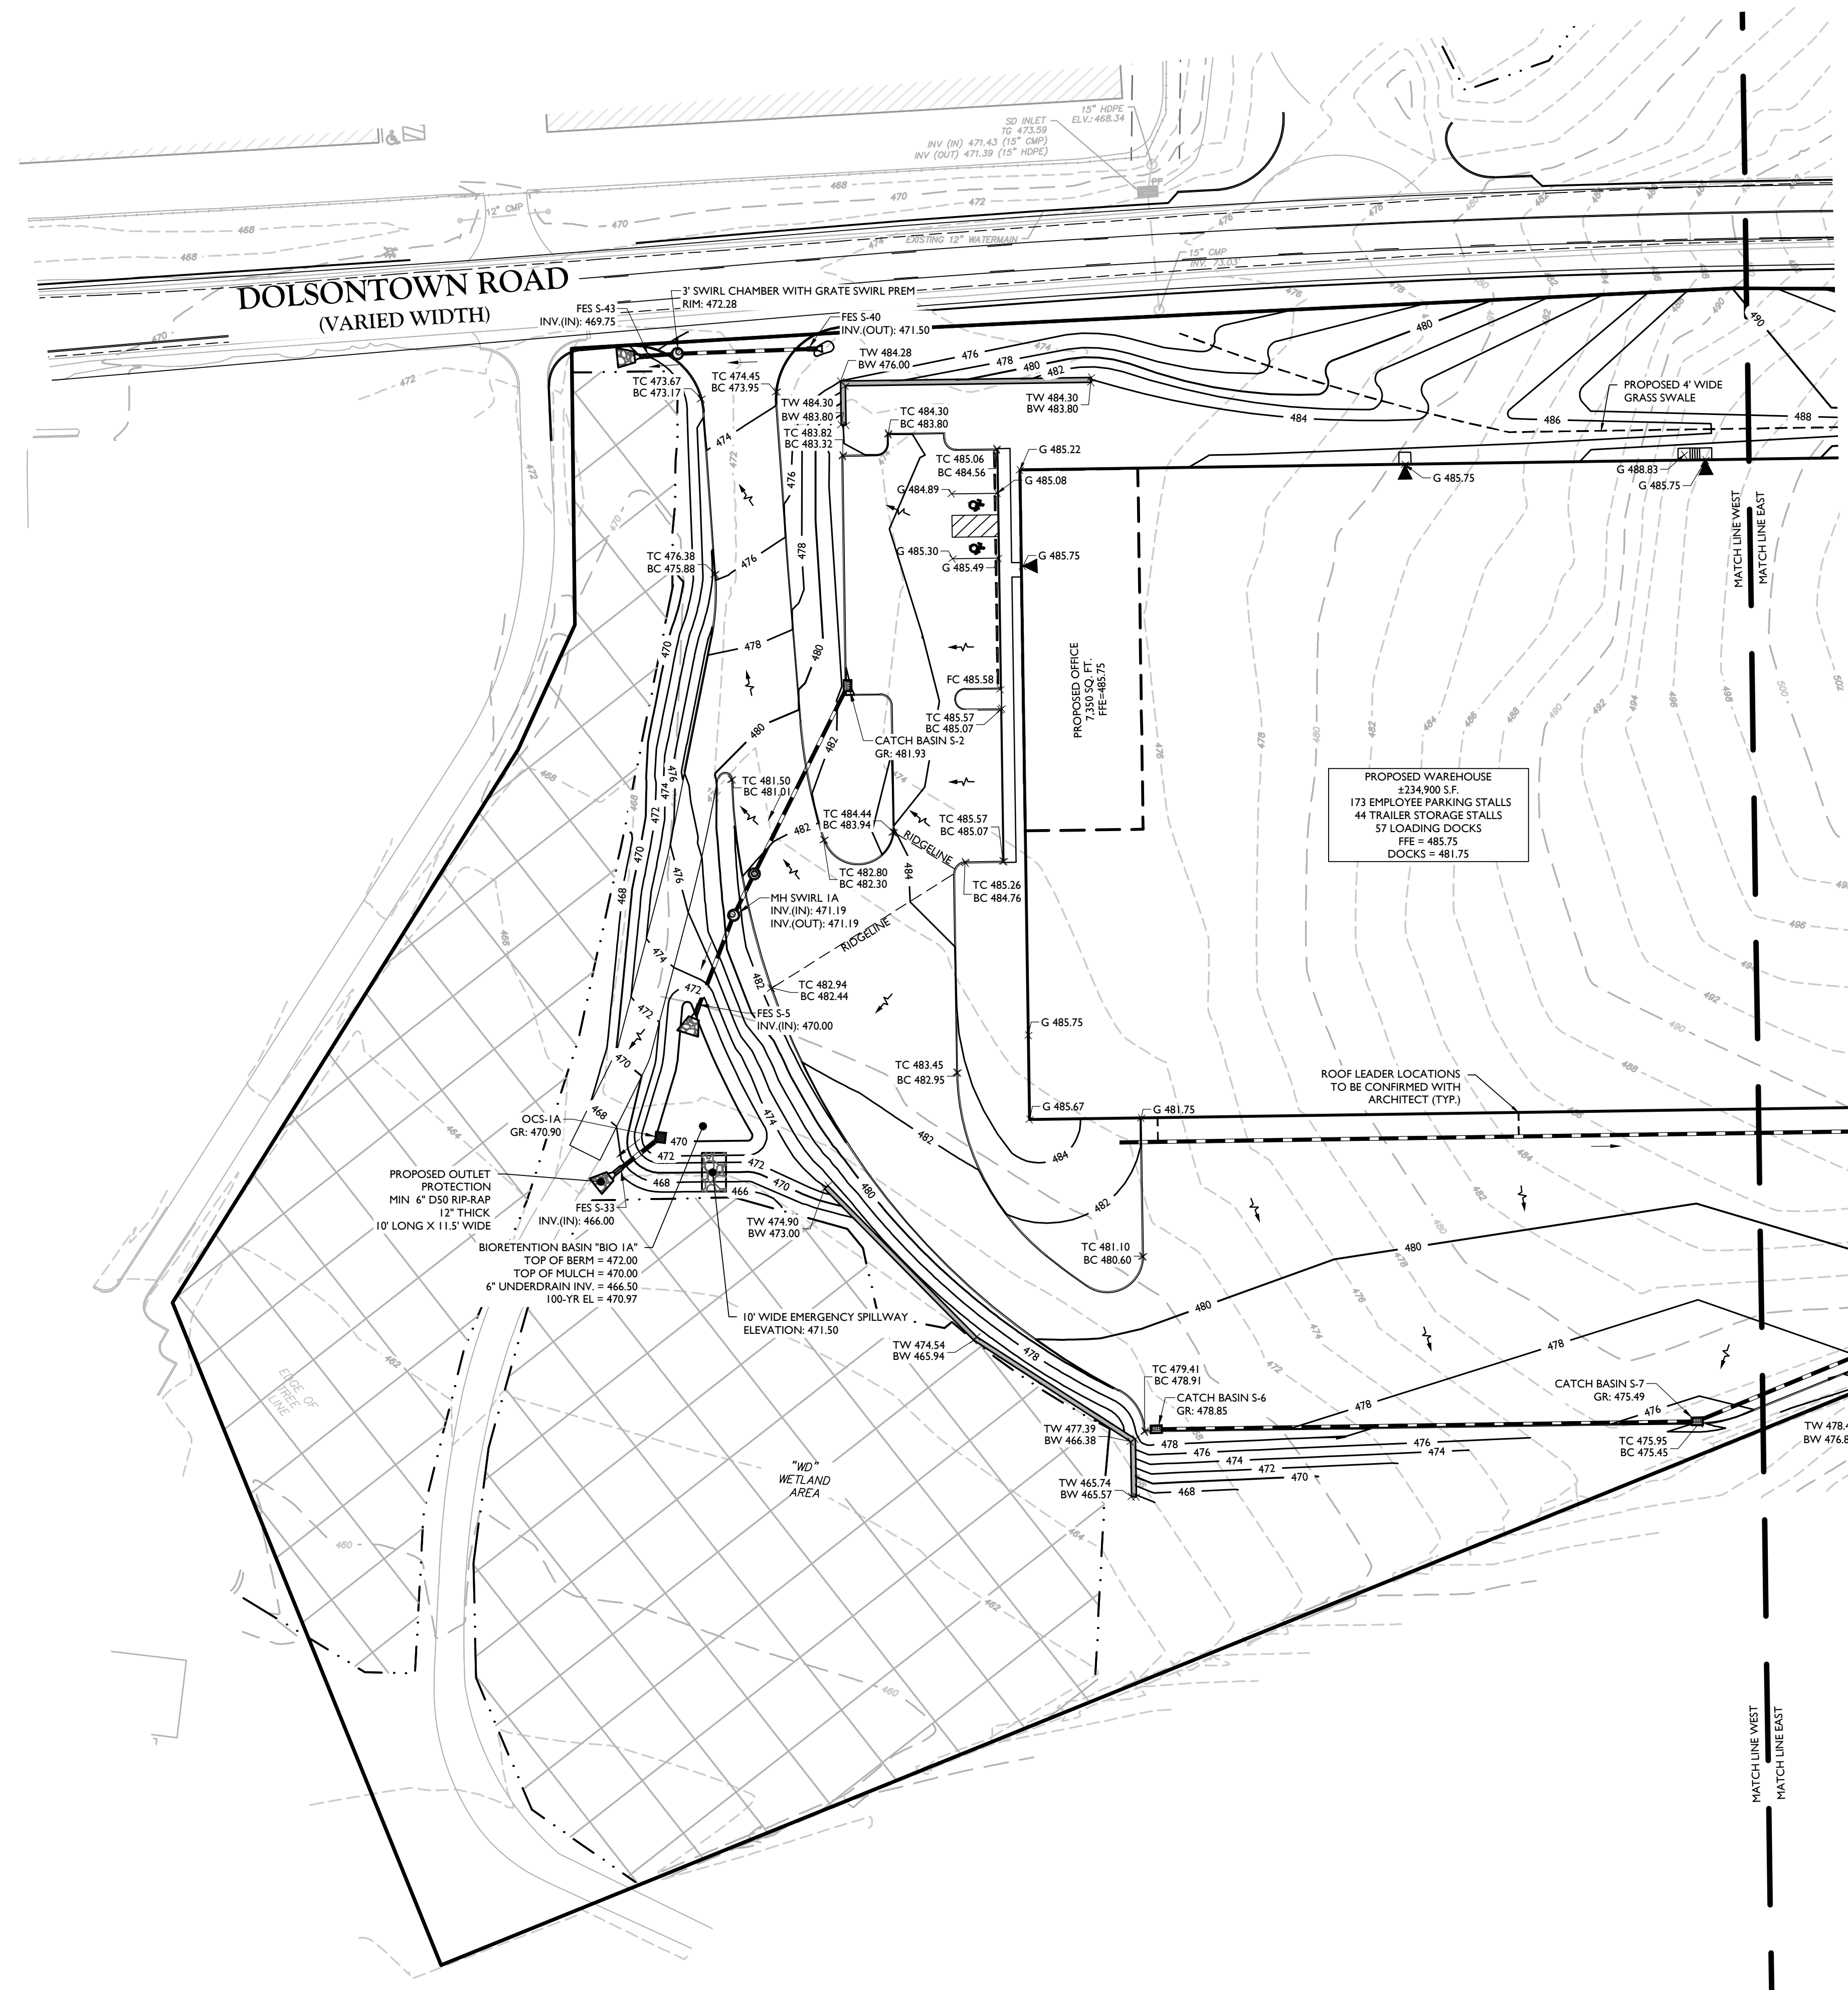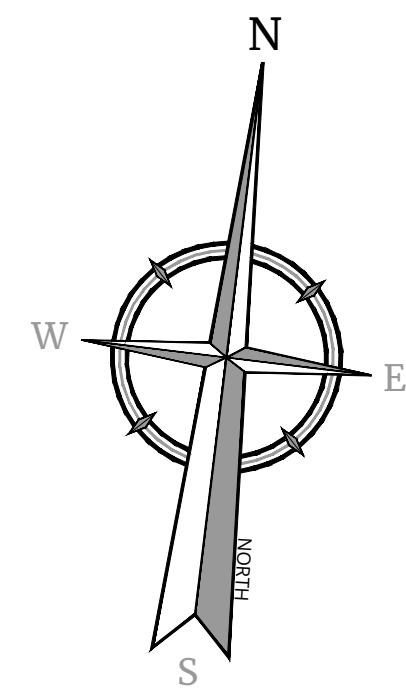

- GRADING NOTES:**
- PROPOSED GRADE ELEVATIONS SHOWN AT BUILDING LINE ARE GROUND ELEVATIONS.
 - PROPOSED SPOT ELEVATIONS IN PAVEMENT AREAS ARE TOP OF FINISHED PAVEMENT.
 - PROVIDE POSITIVE DRAINAGE AWAY FROM BUILDING FOUNDATION.
 - BORING LOCATIONS REFERENCED FROM GEOTECHNICAL DATA REPORT DATE 12/04/2021

- BIORETENTION BASIN NOTES:**
- BIORETENTION BASIN "BIO 1A" IS DESIGNED TO TREAT HOTSPOT RUNOFF. THIS BASIN SHALL BE LINED WITH AN IMPERVIOUS LINER AS TO NOT ALLOW RUNOFF TO INFILTRATE PRIOR TO TREATMENT. SEE BIORETENTION DETAIL FOR EXTENTS OF IMPERVIOUS LINER.

- ADA INSTRUCTIONS TO CONTRACTOR:**
- CONTRACTOR MUST EXERCISE APPROPRIATE CARE AND PRECISION IN CONSTRUCTION OF ADA ACCESSIBLE COMPONENTS FOR THE SITE. THESE COMPONENTS, AS CONSTRUCTED, MUST COMPLY WITH THE LATEST ADA STANDARDS FOR ACCESSIBLE DESIGN. FINISHED SURFACES ALONG THE ACCESSIBLE ROUTE OF TRAVEL FROM PARKING SPACE, PUBLIC TRANSPORTATION, PEDESTRIAN ACCESS, INTER-BUILDING ACCESS, TO POINTS OF ACCESSIBLE BUILDING ENTRANCES/EGRESS, SHALL COMPLY WITH THESE ADA CODE REQUIREMENTS. THESE INCLUDE, BUT ARE NOT LIMITED TO THE FOLLOWING:
 - (NOTE: THIS LIST IS NOT INTENDED TO CAPTURE EVERY APPLICABLE FEDERAL, STATE AND LOCAL RULE AND REGULATION. THE CONTRACTOR IS RESPONSIBLE FOR COMPLIANCE WITH THE LAW, WHETHER OR NOT STATED SPECIFICALLY HEREIN):
 - A. PARKING SPACES AND PARKING AISLES - SLOPE MUST NOT EXCEED 1:48 (1/4" PER FOOT OR NOMINALLY 2.0%) IN ANY DIRECTION.
 - B. CURB RAMPS - SLOPES MUST NOT EXCEED 1:12 (8.3%).
 - C. LANDINGS - MUST BE PROVIDED AT EACH END OF RAMPS. MUST PROVIDE POSITIVE DRAINAGE, AND MUST NOT EXCEED 1:48 (1/4" PER FOOT OR NOMINALLY 2.0%) IN ANY DIRECTION.
 - D. PATH OF TRAVEL ALONG ACCESSIBLE ROUTE - MUST PROVIDE A 36 INCH OR GREATER UNOBSTRUCTED WIDTH OF TRAVEL. (CAR OVERHANGS CANNOT REDUCE THIS MINIMUM WIDTH). THE SLOPE MUST BE NO GREATER THAN 1:20 (5.0%) IN THE DIRECTION OF TRAVEL, AND MUST NOT EXCEED 1:48 (1/4" PER FOOT OR NOMINALLY 2.0%) IN CROSS-SLOPE.
 - E. WHERE PATH OF TRAVEL WILL BE GREATER THAN 1:20 (5.0%), AN ADA RAMP WITH A MAXIMUM SLOPE OF 1:12 (8.3%), FOR A MAXIMUM DISTANCE OF 30 FEET, MUST BE PROVIDED. THE RAMP MUST HAVE ADA HAND RAILS AND "LEVEL" LANDINGS ON EACH END THAT ARE SLOPED NO MORE THAN 1:48 (1/4" PER FOOT OR NOMINALLY 2.0%) FOR POSITIVE DRAINAGE.
 - F. DOORWAYS - MUST HAVE A "LEVEL" LANDING AREA ON THE EXTERIOR SIDE OF THE DOOR THAT IS SLOPED NO MORE THAN 1:48 (1/4" PER FOOT OR NOMINALLY 2.0%) FOR POSITIVE DRAINAGE. THIS LANDING AREA MUST BE NO LESS THAN 60 INCHES (5 FEET) LONG, EXCEPT WHERE OTHERWISE PERMITTED BY ADA STANDARDS FOR ALTERNATIVE DOORWAY OPENING CONDITIONS (SEE APPLICABLE CODE SECTIONS).
 - IT IS RECOMMENDED THAT THE CONTRACTOR REVIEW THE INTENDED CONSTRUCTION WITH THE LOCAL BUILDING CODE OFFICIAL PRIOR TO COMMENCING WORK.

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N.Y. C.O.A.# 0017069

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SBL: 4-1-50.32, 6-1-90.22,
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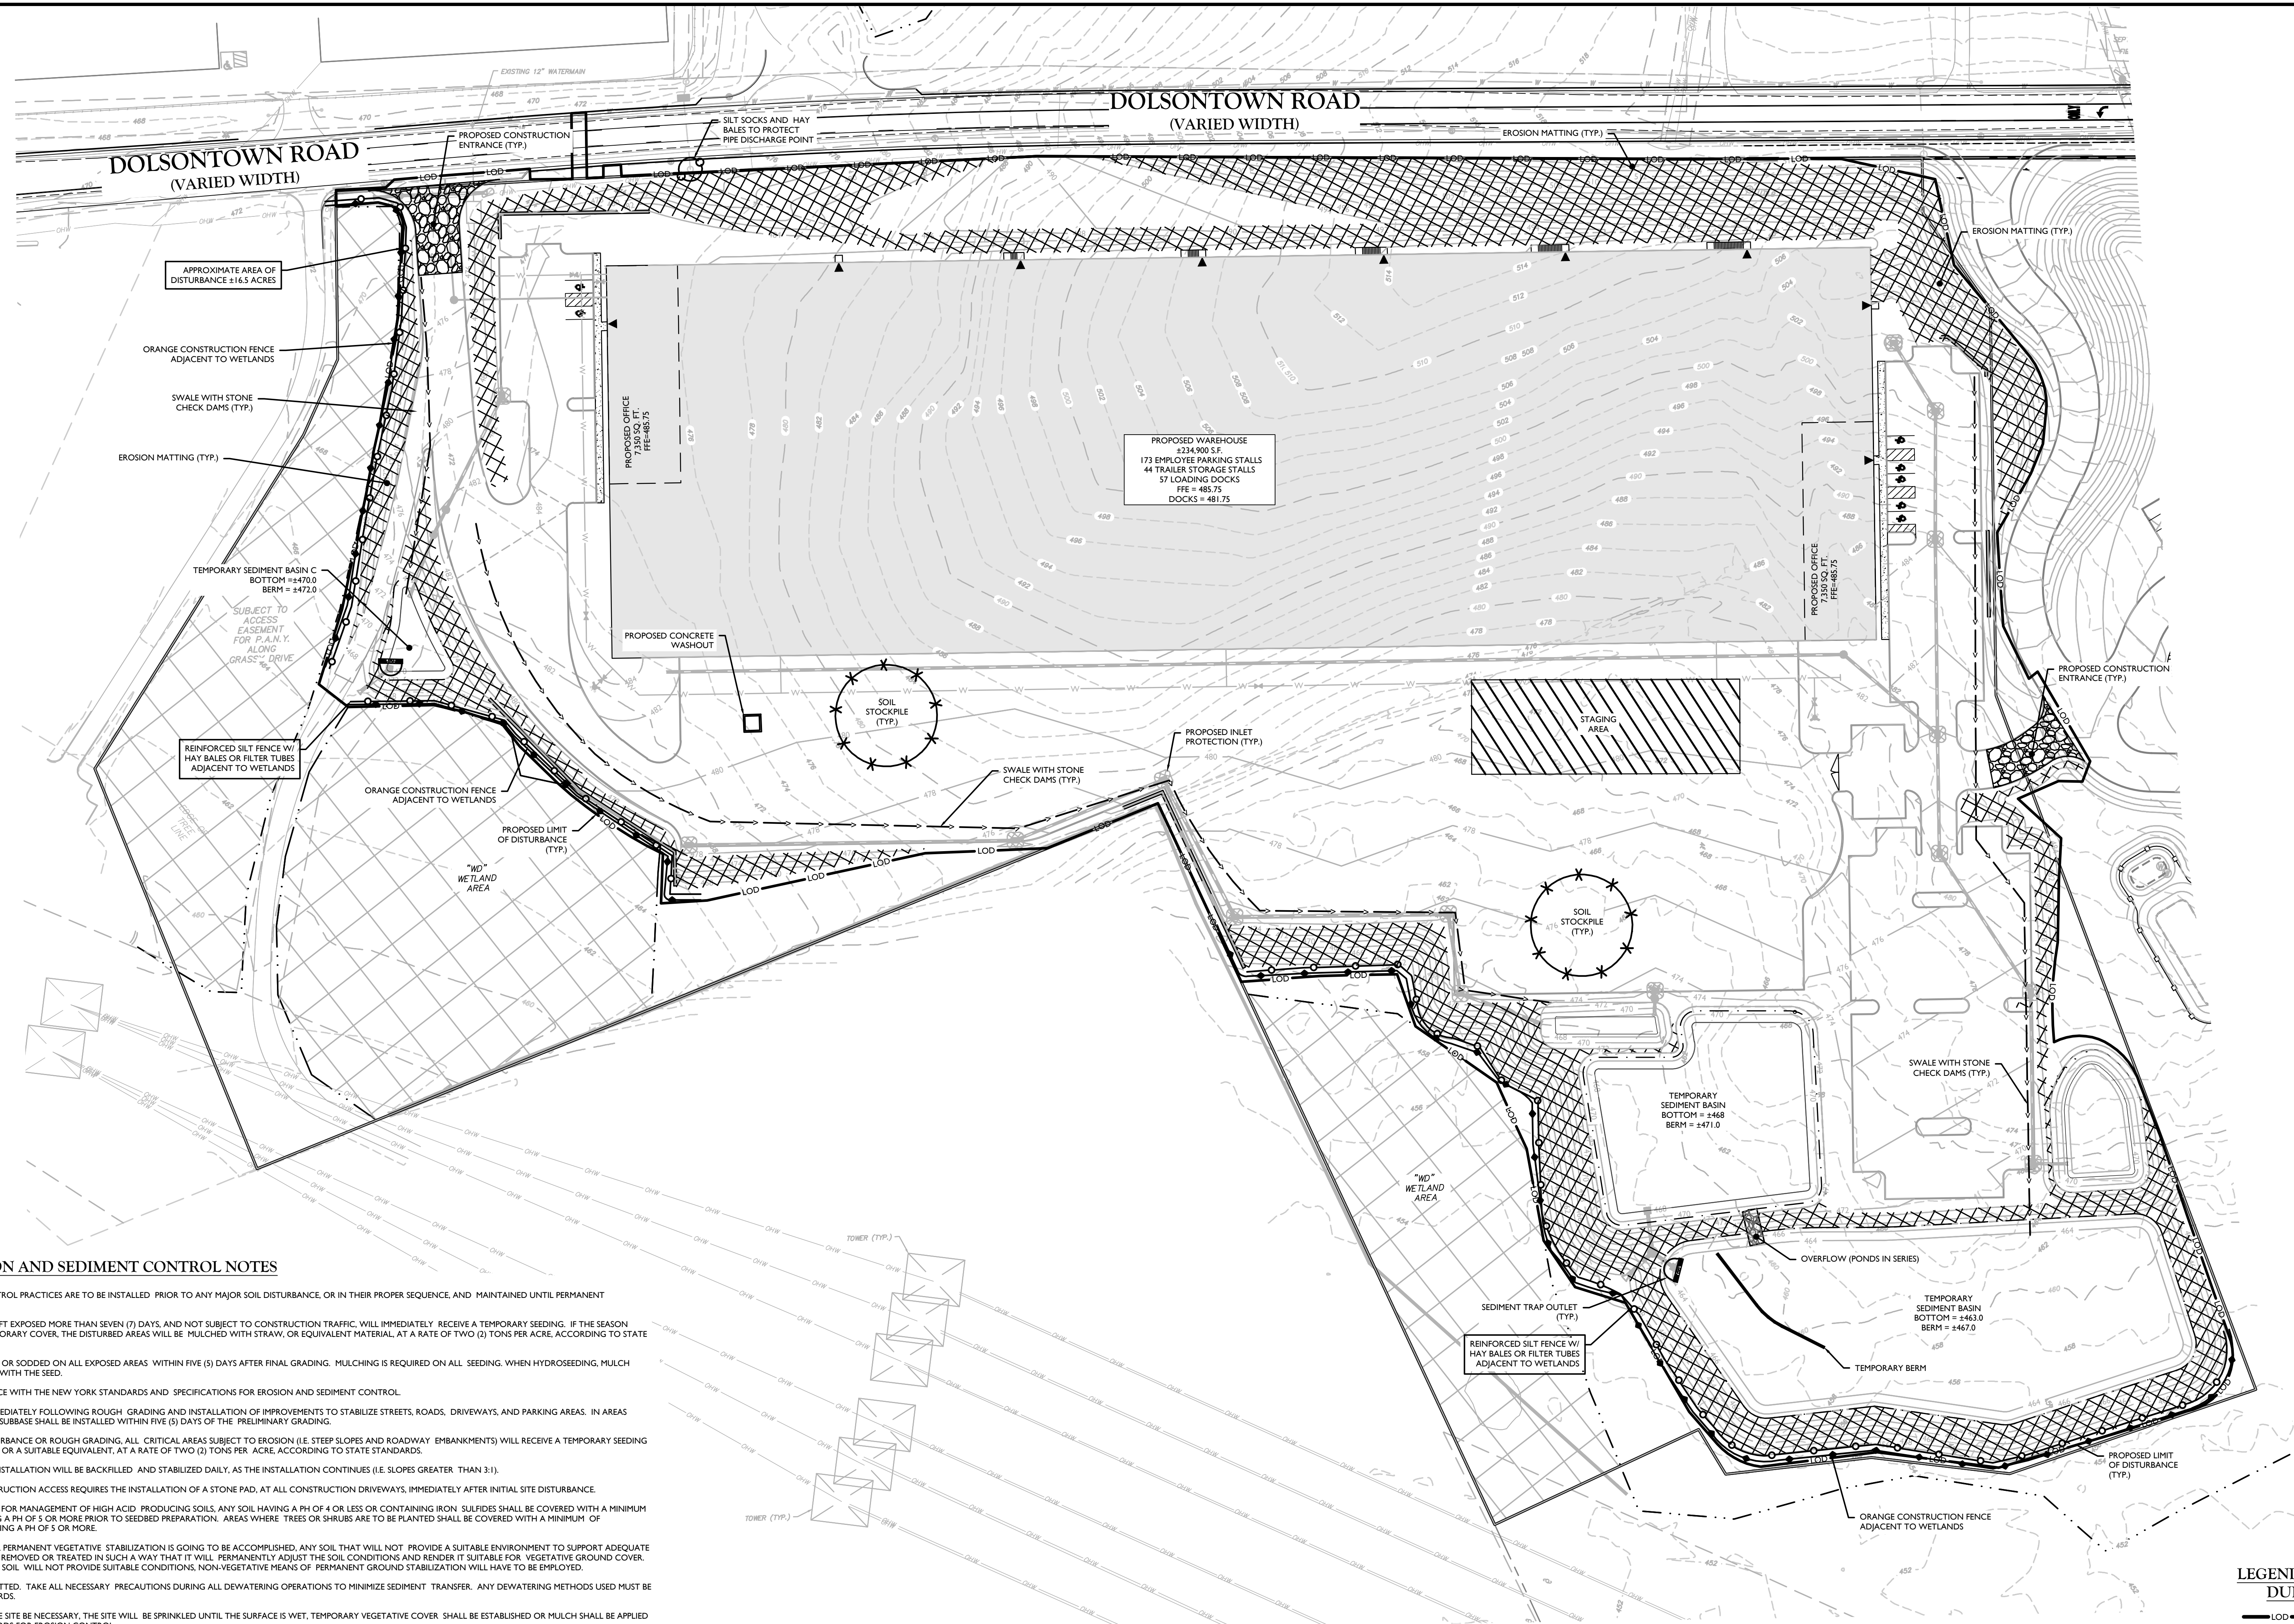
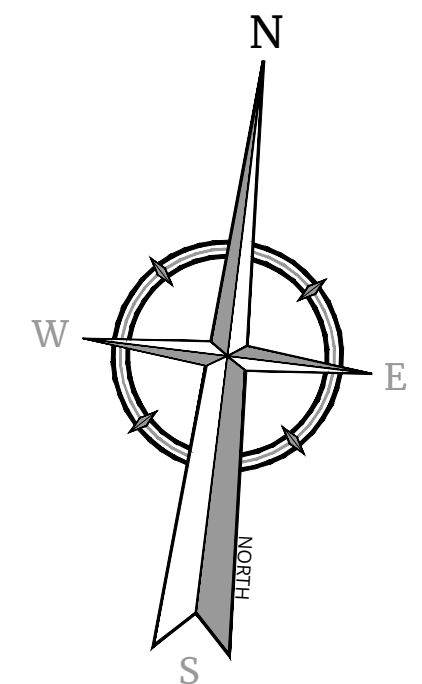
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SURVEYING, C.T.P.C.

SCALE: AS SHOWN
DATE: 04/08/2024
PROJECT NUMBER: 20006912E
DRAWING NAME: C-GRAD
DRAWN BY: MAS
CHECKED BY: CDR
SHEET TITLE: GRADING & DRAINAGE PLAN WEST
SHEET NUMBER: C-401



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GENERAL SOIL EROSION AND SEDIMENT CONTROL NOTES

- 1. ALL SOIL EROSION AND SEDIMENT CONTROL PRACTICES ARE TO BE INSTALLED PRIOR TO ANY MAJOR SOIL DISTURBANCE, OR IN THEIR PROPER SEQUENCE, AND MAINTAINED UNTIL PERMANENT PROTECTION IS ESTABLISHED.
2. ANY DISTURBED AREAS THAT WILL BE LEFT EXPOSED MORE THAN SEVEN (7) DAYS, AND NOT SUBJECT TO CONSTRUCTION TRAFFIC, WILL IMMEDIATELY RECEIVE A TEMPORARY SEEDING. IF THE SEASON PREVENTS THE ESTABLISHMENT OF TEMPORARY COVER, THE DISTURBED AREAS WILL BE MULCHED WITH STRAW, OR EQUIVALENT MATERIAL, AT A RATE OF TWO (2) TONS PER ACRE, ACCORDING TO STATE STANDARDS.
3. PERMANENT VEGETATION TO BE SEED OR SOODED ON ALL EXPOSED AREAS WITHIN FIVE (5) DAYS AFTER FINAL GRADING. MULCHING IS REQUIRED ON ALL SEEDING. WHEN HYDROSEEDING, MULCH SHALL NOT BE INCLUDED IN THE TANK WITH THE SEED.
4. ALL WORK TO BE DONE IN ACCORDANCE WITH THE NEW YORK STANDARDS AND SPECIFICATIONS FOR EROSION AND SEDIMENT CONTROL.
5. A SUBBASE COURSE WILL BE APPLIED IMMEDIATELY FOLLOWING ROUGH GRADING AND INSTALLATION OF IMPROVEMENTS TO STABILIZE STREETS, ROADS, DRIVEWAYS, AND PARKING AREAS. IN AREAS WHERE NO UTILITIES ARE PRESENT, THE SUBBASE SHALL BE INSTALLED WITHIN FIVE (5) DAYS OF THE PRELIMINARY GRADING.
6. IMMEDIATELY FOLLOWING INITIAL DISTURBANCE OR ROUGH GRADING, ALL CRITICAL AREAS SUBJECT TO EROSION (I.E. STEEP SLOPES AND ROADWAY EMBANKMENTS) WILL RECEIVE A TEMPORARY SEEDING IN COMBINATION WITH STRAW MULCH OR A SUITABLE EQUIVALENT, AT A RATE OF TWO (2) TONS PER ACRE, ACCORDING TO STATE STANDARDS.
7. ANY STEEP SLOPES RECEIVING PIPELINE INSTALLATION WILL BE BACKFILLED AND STABILIZED DAILY, AS THE INSTALLATION CONTINUES (I.E. SLOPES GREATER THAN 3:1).
8. THE STANDARD FOR STABILIZED CONSTRUCTION ACCESS REQUIRES THE INSTALLATION OF A STONE PAD, AT ALL CONSTRUCTION DRIVEWAYS, IMMEDIATELY AFTER INITIAL SITE DISTURBANCE.
9. IN ACCORDANCE WITH THE STANDARD FOR MANAGEMENT OF HIGH ACID PRODUCING SOILS, ANY SOIL HAVING A PH OF 4 OR LESS OR CONTAINING IRON SULFIDES SHALL BE COVERED WITH A MINIMUM OF TWELVE (12) INCHES OF SOIL, HAVING A PH OF 5 OR MORE PRIOR TO SEEDING PREPARATION. AREAS WHERE TREES OR SHRUBS ARE TO BE PLANTED SHALL BE COVERED WITH A MINIMUM OF TWENTY-FOUR (24) INCHES OF SOIL, HAVING A PH OF 5 OR MORE.
10. AT THE TIME THE SITE PREPARATION FOR PERMANENT VEGETATIVE STABILIZATION IS GOING TO BE ACCOMPLISHED, ANY SOIL THAT WILL NOT PROVIDE A SUITABLE ENVIRONMENT TO SUPPORT ADEQUATE VEGETATIVE GROUND COVER, SHALL BE REMOVED OR TREATED IN SUCH A WAY THAT IT WILL PERMANENTLY ADJUST THE SOIL CONDITIONS AND RENDER IT SUITABLE FOR VEGETATIVE GROUND COVER. IF THE REMOVAL OR TREATMENT OF THE SOIL, WILL NOT PROVIDE SUITABLE CONDITIONS, NON-VEGETATIVE MEANS OF PERMANENT GROUND STABILIZATION WILL HAVE TO BE EMPLOYED.
11. UNFILTERED DEWATERING IS NOT PERMITTED. TAKE ALL NECESSARY PRECAUTIONS DURING ALL DEWATERING OPERATIONS TO MINIMIZE SEDIMENT TRANSFER. ANY DEWATERING METHODS USED MUST BE IN ACCORDANCE WITH STATE STANDARDS.
12. SHOULD THE CONTROL OF DUST AT THE SITE BE NECESSARY, THE SITE WILL BE SPRINKLED UNTIL THE SURFACE IS WET, TEMPORARY VEGETATIVE COVER SHALL BE ESTABLISHED OR MULCH SHALL BE APPLIED IN ACCORDANCE WITH STATE STANDARDS FOR EROSION CONTROL.
13. ALL SOIL WASHED, DROPPED, SPILLED, OR TRACKED OUTSIDE THE LIMIT OF DISTURBANCE OR ONTO PUBLIC RIGHT-OF-WAY WILL BE REMOVED IMMEDIATELY.
14. THE PROPERTY OWNER SHALL BE RESPONSIBLE FOR ANY EROSION AND SEDIMENTATION THAT MAY OCCUR BELOW STORMWATER OUTFALLS OR OFFSITE AS A RESULT OF CONSTRUCTION OF THE PROJECT.
15. STOCKPILES AND STAGING LOCATIONS DETERMINED IN THE FIELD, SHALL BE PLACED WITHIN THE LIMITS OF DISTURBANCE ACCORDING TO THE CERTIFIED PLAN.
16. CONCRETE WASHOUT, DUMPSITE, & STAGING AREA LOCATIONS SHALL BE DETERMINED BY THE CONTRACTOR AND APPROVED AT THE PRE-CONSTRUCTION MEETING. THEY SHALL BE PLACED IN THE PROXIMITY OF THE CONSTRUCTION ENTRANCE AND STAGING AREAS AND SHALL BE USED PRIOR TO EXITING THE PROJECT SITE. THE LOCATION SHALL BE IN A PRACTICAL, CLEARLY DELINEATED, AREA AND BE MAINTAINED THROUGHOUT CONSTRUCTION.
17. ALL SOIL STOCKPILES ARE TO BE TEMPORARILY STABILIZED IN ACCORDANCE WITH THE NEW YORK STATE STANDARDS AND SPECIFICATIONS FOR SOIL EROSION AND SEDIMENT CONTROL.
18. ALL PERMANENT SOIL EROSION AND SEDIMENT CONTROL MEASURES SHALL BE MAINTAINED BY THE PROPERTY OWNER, AND SHALL BECOME THEIR RESPONSIBILITY.
19. PAVEMENT AREAS ARE TO BE KEPT CLEAN AT ALL TIMES.
20. DURING CONSTRUCTION, ANY ADDITIONAL CONTROL MEASURES AS DEEMED NECESSARY TO PREVENT EROSION OR CONTROL SEDIMENT BEYOND THOSE MEASURES SHOWN ON THE APPROVED PLAN SHALL BE INSTALLED OR EMPLOYED AT THE DIRECTION OF THE MUNICIPAL ENGINEER.
21. REFER TO GEOTECHNICAL REPORT FOR ADDITIONAL EROSION AND SEDIMENT CONTROL MEASURES.

FINAL STABILIZATION - MEANS THAT ALL SOIL DISTURBANCE ACTIVITIES HAVE CEASED AND A UNIFORM, PERENNIAL VEGETATIVE COVER WITH A DENSITY OF EIGHTY (80) PERCENT OVER THE ENTIRE PERVIOUS SURFACE HAS BEEN ESTABLISHED, OR OTHER EQUIVALENT STABILIZATION MEASURES, SUCH AS PERMANENT LANDSCAPE MULCHES, ROCK RIP-RAP OR WASHED/CUSHED STONE HAVE BEEN APPLIED ON ALL DISTURBED AREAS THAT ARE NOT COVERED BY PERMANENT STRUCTURES, CONCRETE OR PAVEMENT.

INSPECTION AND MAINTENANCE SHALL BE PERFORMED IN CONFORMANCE WITH GR-0-20.001. ALL EROSION AND SEDIMENT CONTROL PRACTICES WILL BE CHECKED FOR STABILITY AND OPERATION FOLLOWING EVERY RUNOFF-PRODUCING RAINFALL BUT IN NO CASE LESS THAN ONCE EVERY WEEK. ANY NEEDED REPAIRS WILL BE MADE IMMEDIATELY TO MAINTAIN ALL PRACTICES AS DESIGNED AND INSTALLED FOR THE PROJECT. THE SEDIMENT TRAPS WILL BE CLEANED OUT WHEN THE LEVEL OF SEDIMENT REACHES 25% OF ITS CAPACITY. SEDIMENT WILL BE REMOVED FROM BEHIND THE SILT FENCE WHEN IT BECOMES APPROXIMATELY 1' DEEP AT THE FENCE. THE SEDIMENT FENCE WILL BE REPAIRED AS NECESSARY TO MAINTAIN A BARRIER. ALL SEEDED AREAS WILL BE FERTILIZED, RE-SEEDING AS NECESSARY, AND MULCHED ACCORDING TO SPECIFICATIONS IN THE LANDSCAPE PLAN TO MAINTAIN A VIGOROUS, DENSE VEGETATIVE COVER.


NOTE DURING THE CONSTRUCTION OF A PHASE, EACH SUBSEQUENT PHASE WILL HAVE BEEN CAPPED AND STABILIZED WITH DENSE GRASS COVER.

MAINTENANCE AGREEMENT NOTE

THE OWNER/APPLICANT SHALL ENTER INTO AN ENFORCEABLE MAINTENANCE AGREEMENT WITH THE MUNICIPALITY RELATED TO MAINTENANCE OF STORMWATER FACILITIES. THE OWNER/APPLICANT IS RESPONSIBLE TO PERFORM ALL REQUIRED MAINTENANCE BOTH DURING CONSTRUCTION AND LONG-TERM. THE NATURE OF THE AGREEMENT IS TO ALLOW THE VILLAGE TO PERFORM MAINTENANCE AT THEIR OPTION SHOULD THE OWNER/APPLICANT FAIL TO ADEQUATELY MAINTAIN THE SYSTEM AS DETERMINED BY THE MUNICIPAL ENGINEER. MAINTENANCE OF THE STORMWATER SYSTEM SHALL BE PERFORMED IN ACCORDANCE WITH THE APPROVED SWPPP AND DETAIL SHEETS.

LEGEND FOR EROSION CONTROL DURING CONSTRUCTION

- CONSTRUCTION LIMIT LINE
SILT FENCE
ORANGE CONSTRUCTION FENCE
STORM INLET SEDIMENT TRAP
STABILIZED CONSTRUCTION ENTRANCE
STONE OUTLET SEDIMENT TRAP
TEMPORARY SWALE
TEMPORARY SEDIMENT BASIN
MATERIAL STOCKPILE
CONCRETE WASHOUT

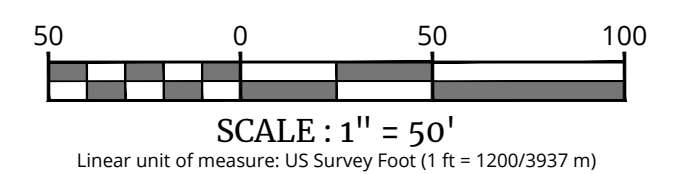

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Table with columns: REV, DATE, DRAWN BY, DESCRIPTION

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PRELIMINARY SITE PLAN FOR DEWPOINT SOUTH
SBL: 4-1-50.32, 6-1-90.22, 90.24 & 107
TOWN OF WAWAYANDA ORANGE COUNTY NEW YORK STATE

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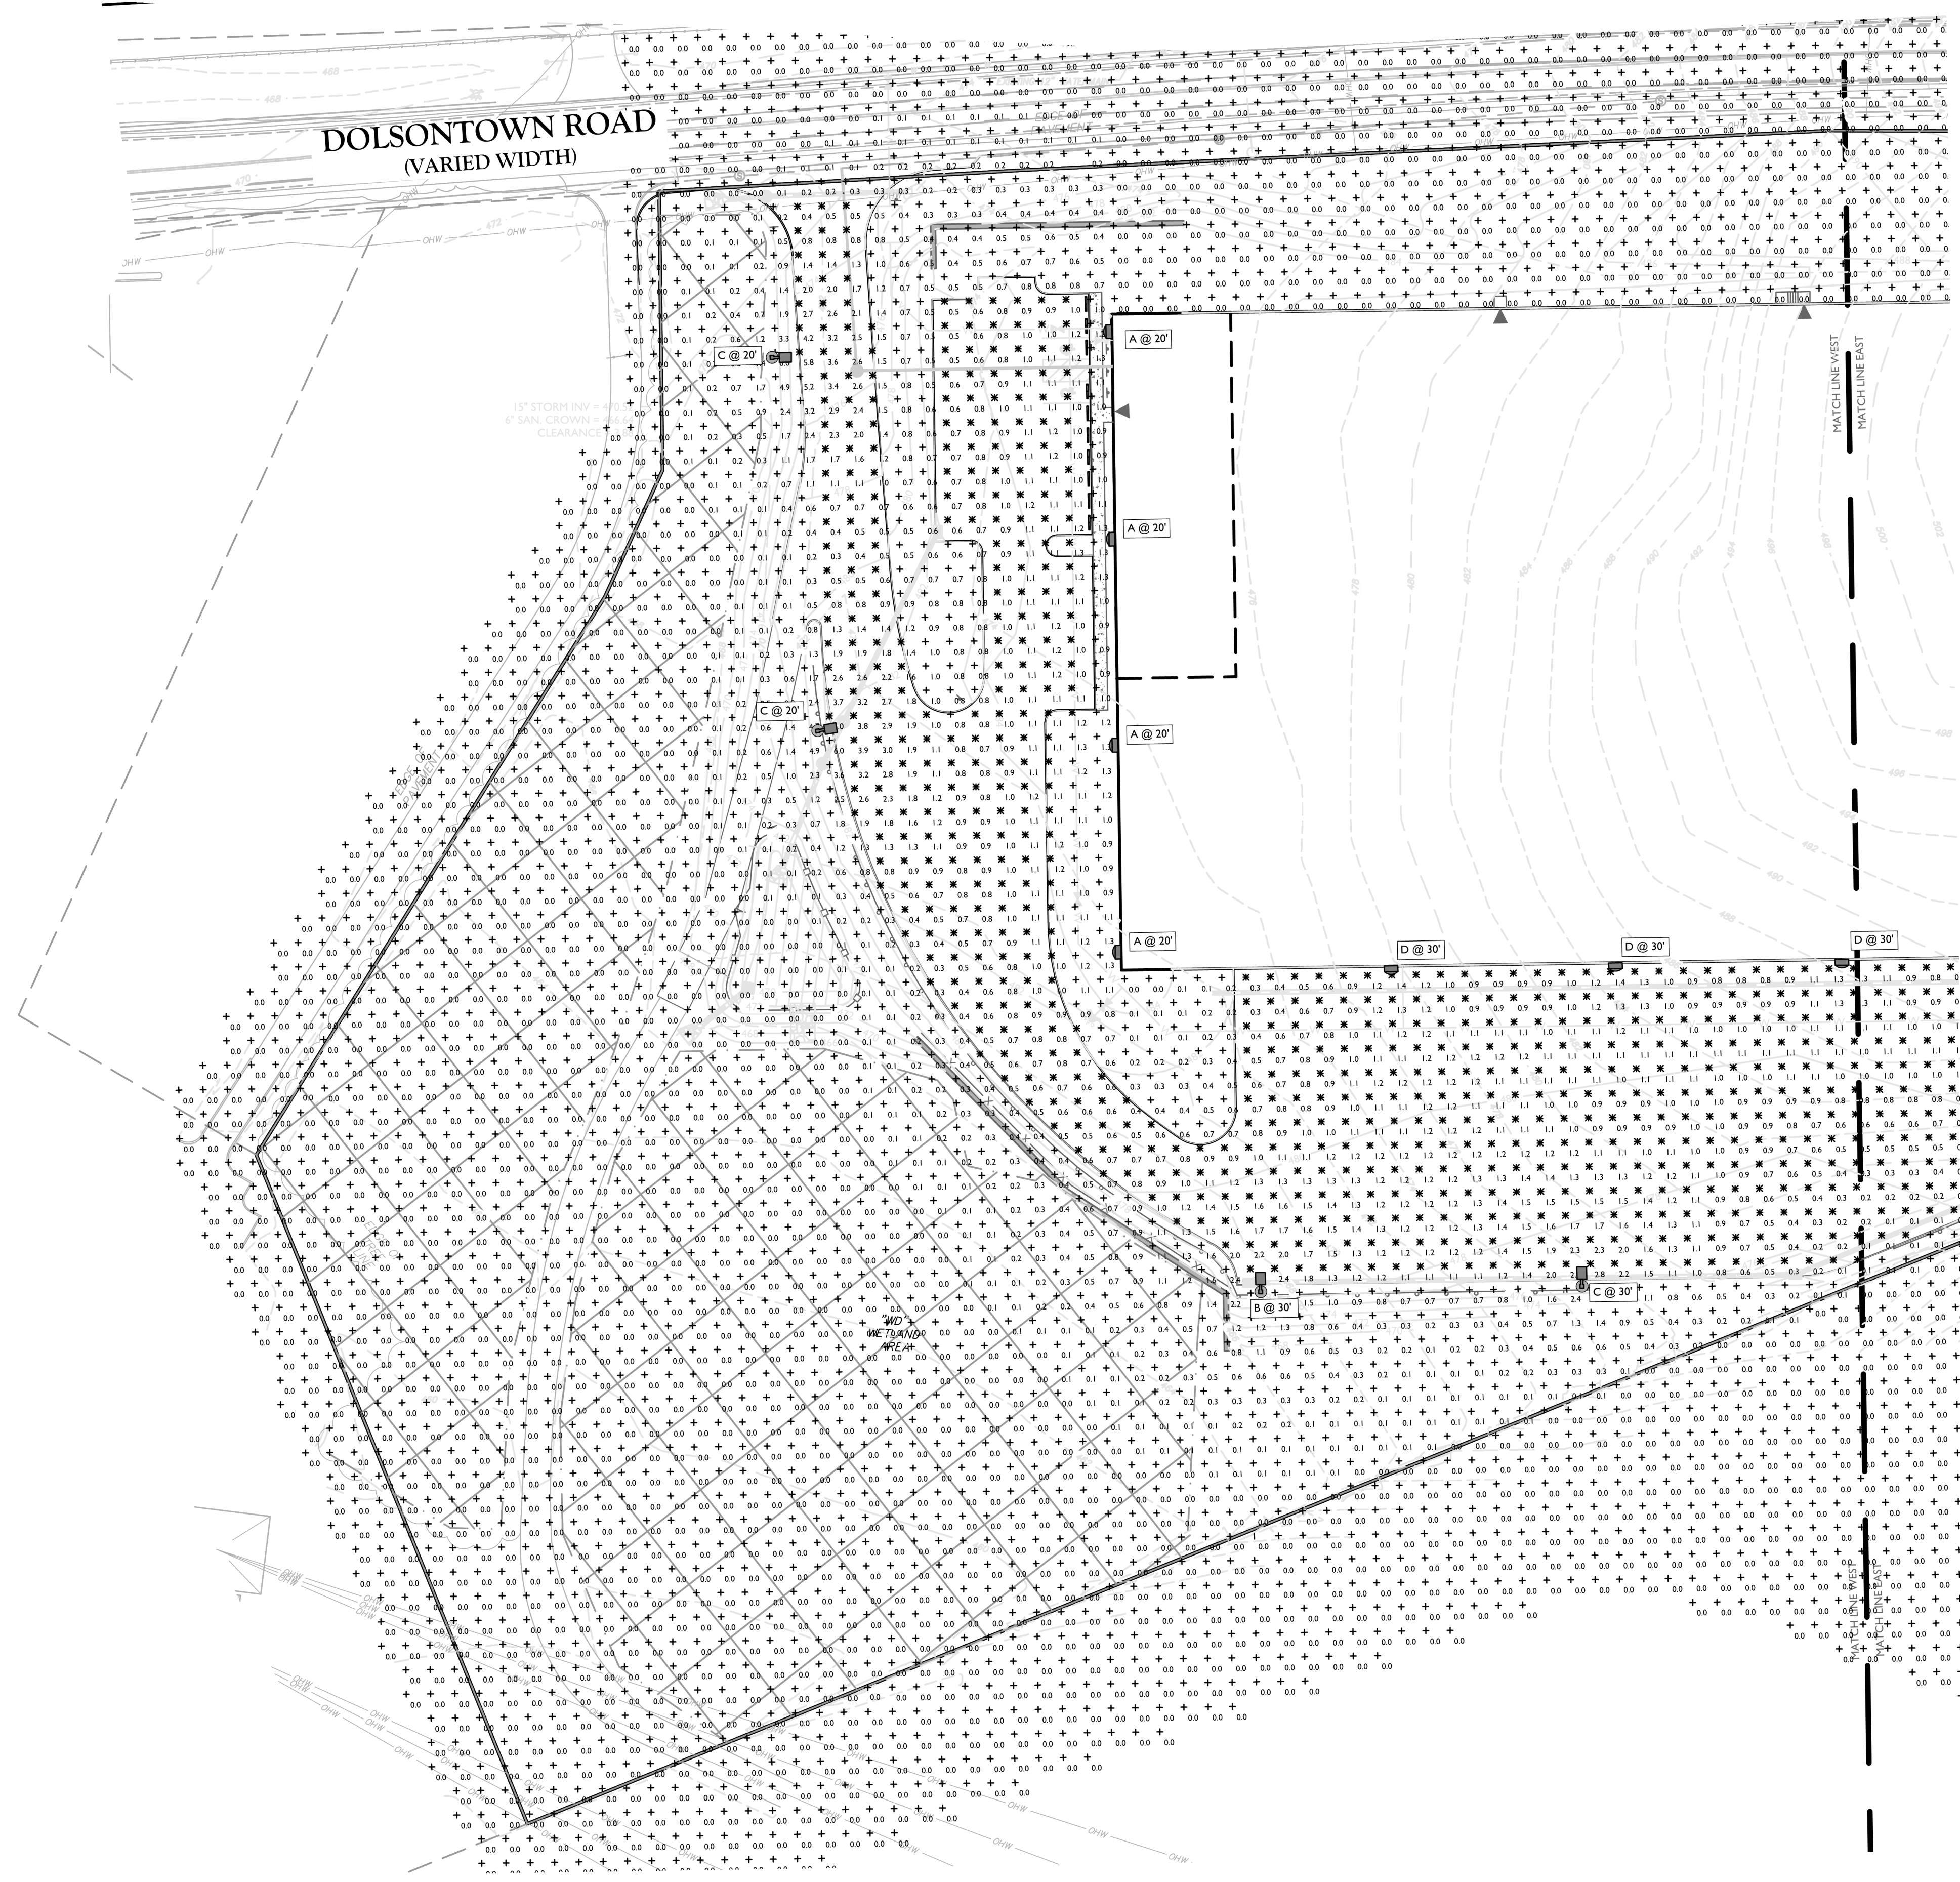
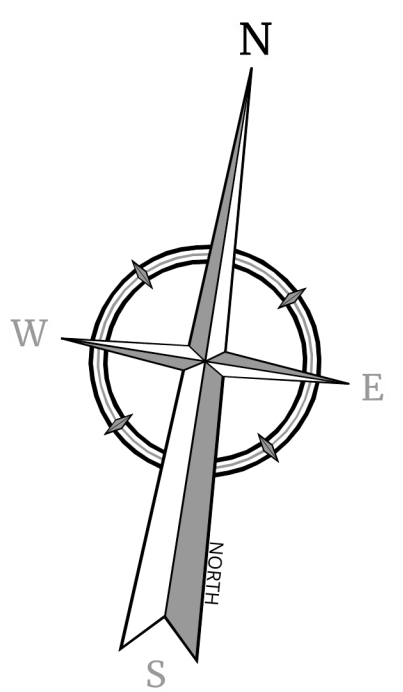
PROJECT NUMBER: 20006912E, DRAWING NAME: C-SEDC

SHEET TITLE: SOIL EROSION & SEDIMENT CONTROL PLAN

SHEET NUMBER: C-600



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LIGHTING NOTES:

- THIS PLAN IS TO BE USED FOR LIGHTING PURPOSES ONLY.
- POLES AND FIXTURES AS SUPPLIED BY:
POLES & WALL FIXTURES - HOLOPHANE
POLE FIXTURES - AMERICAN ELECTRIC LIGHTING
- LAMPS ARE TO BE LED. A LIGHT LOSS FACTOR (LLF) WAS USED AS SHOWN IN THE LUMINAIRES SCHEDULE.
- FIXTURES AND POLES ARE TO BE BLACK.
- POLE MOUNTED FIXTURES SHALL BE PLACED A MINIMUM OF TWO (2) FEET BEHIND CURBS, EDGE OF PAVEMENT OR RETAINING WALLS IN CAR PARKING AREAS.
- PROPOSED LIGHT FIXTURE LOCATIONS ARE CRITICAL TO PROVIDE THE LIGHTING LEVELS DEPICTED ON THIS PLAN. THE LIGHTING CONTRACTOR SHALL FIELD VERIFY FIXTURE LOCATIONS PRIOR TO INSTALLATION. IF ADJUSTMENT TO ANY LIGHT FIXTURE LOCATION IS REQUIRED DUE TO CONSTRUCTION OF UTILITIES AND SITE IMPROVEMENTS, THE LIGHTING CONTRACTOR SHALL NOTIFY THE PROJECT LANDSCAPE ARCHITECT OF ANY DISCREPANCIES PRIOR TO INSTALLATION.
- LIGHTING SHOWN ON PLAN DEPICTS AVERAGE MAINTAINED FOOTCANDLE LEVELS AT GRADE.
- CONTRACTOR TO PROVIDE SHOP DRAWINGS OF LIGHT FIXTURES FOR REVIEW AND APPROVAL BY THE OWNER OR PROJECT LANDSCAPE ARCHITECT.
- ELECTRICAL PLANS FOR WIRING LAYOUT BY OTHERS.
- POLE BASE INSTALLATION SHALL INCLUDE A SUPPLEMENTARY GROUND ROD AND WIRE LEAD TO BASE FOR POWER CONNECTION. DETAILS PER PROJECT ELECTRICAL ENGINEER.
- ALL LIGHTING FIXTURES WILL BE DARK SKY COMPLIANT.

CALCULATION SUMMARY


| DESCRIPTION | CALC. TYPE | UNITS | AVG. | MAX. | MIN. | AVG. / MIN. |
|-------------------------------------|-------------|-------|------|------|------|-------------|
| WESTERN DRIVEWAY | ILLUMINANCE | FC | 1.3 | 6.0 | 0.3 | 4.3:1 |
| LOADING DOCK & TRAILER STORAGE AREA | ILLUMINANCE | FC | 1.0 | 5.4 | 0.1 | 10.0:1 |
| WESTERN PARKING AREA | ILLUMINANCE | FC | 1.0 | 1.3 | 0.5 | 2.0:1 |
| EASTERN PARKING AREA | ILLUMINANCE | FC | 1.5 | 5.9 | 0.3 | 5.0:1 |

LUMINAIRE SCHEDULE

| KEY | QTY. | DESCRIPTION | ARRANGEMENT | MTG. HT. | LUMENS/LAMP | LLF | CATALOG # |
|-----|------|--|------------------|----------|-------------|------|---------------------------------------|
| A | 7 | HOLOPHANE WALL PACK FULL CUTOFF LED | SINGLE WALL PACK | 20/30' | 5,144 | 0.97 | HLWPC2-P20-30K-MVOLT*-R4-3K-BK-UMS-XX |
| B | 7 | AMERICAN ELECTRIC LIGHTING - ATB0 SERIES LED | SINGLE | 30' | 20,049 | 0.97 | ATB0-P305-MVOLT*-R4-3K-BK-UMS-XX |
| B2 | 2 | AMERICAN ELECTRIC LIGHTING - ATB0 SERIES LED | DOUBLE @ 90° | 30' | 20,049 | 0.97 | ATB0-P305-MVOLT*-R4-3K-BK-UMS-XX |
| C | 4 | AMERICAN ELECTRIC LIGHTING - ATB0 SERIES LED | SINGLE | 20/30' | 16,557 | 0.97 | ATB0-P305-MVOLT*-R4-3K-BK-HSS-UMS-XX |
| D | 8 | HOLOPHANE WALL PACK FULL CUTOFF LED | SINGLE WALL PACK | 30' | 9,561 | 0.97 | HLWPC2-P40-30K-MVOLT*-R4-3K-BK-UMS-XX |

LIGHTING LEGEND:

- SINGLE FIXTURE POLE LIGHT
- WALLPACK
- LIGHT LEVEL AT GRADE (IN FOOT CANDLES)

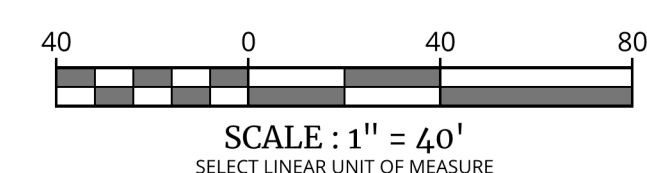

TOWN OF WAWAYANDA PLANNING BOARD

PRELIMINARY SITE PLAN FOR DEWPOINT SOUTH

SBL: 4-1-50.32, 6-1-90.22, 90.24 & 107

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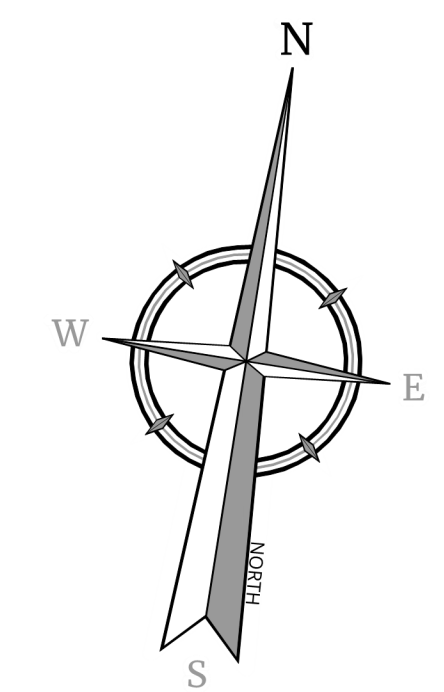
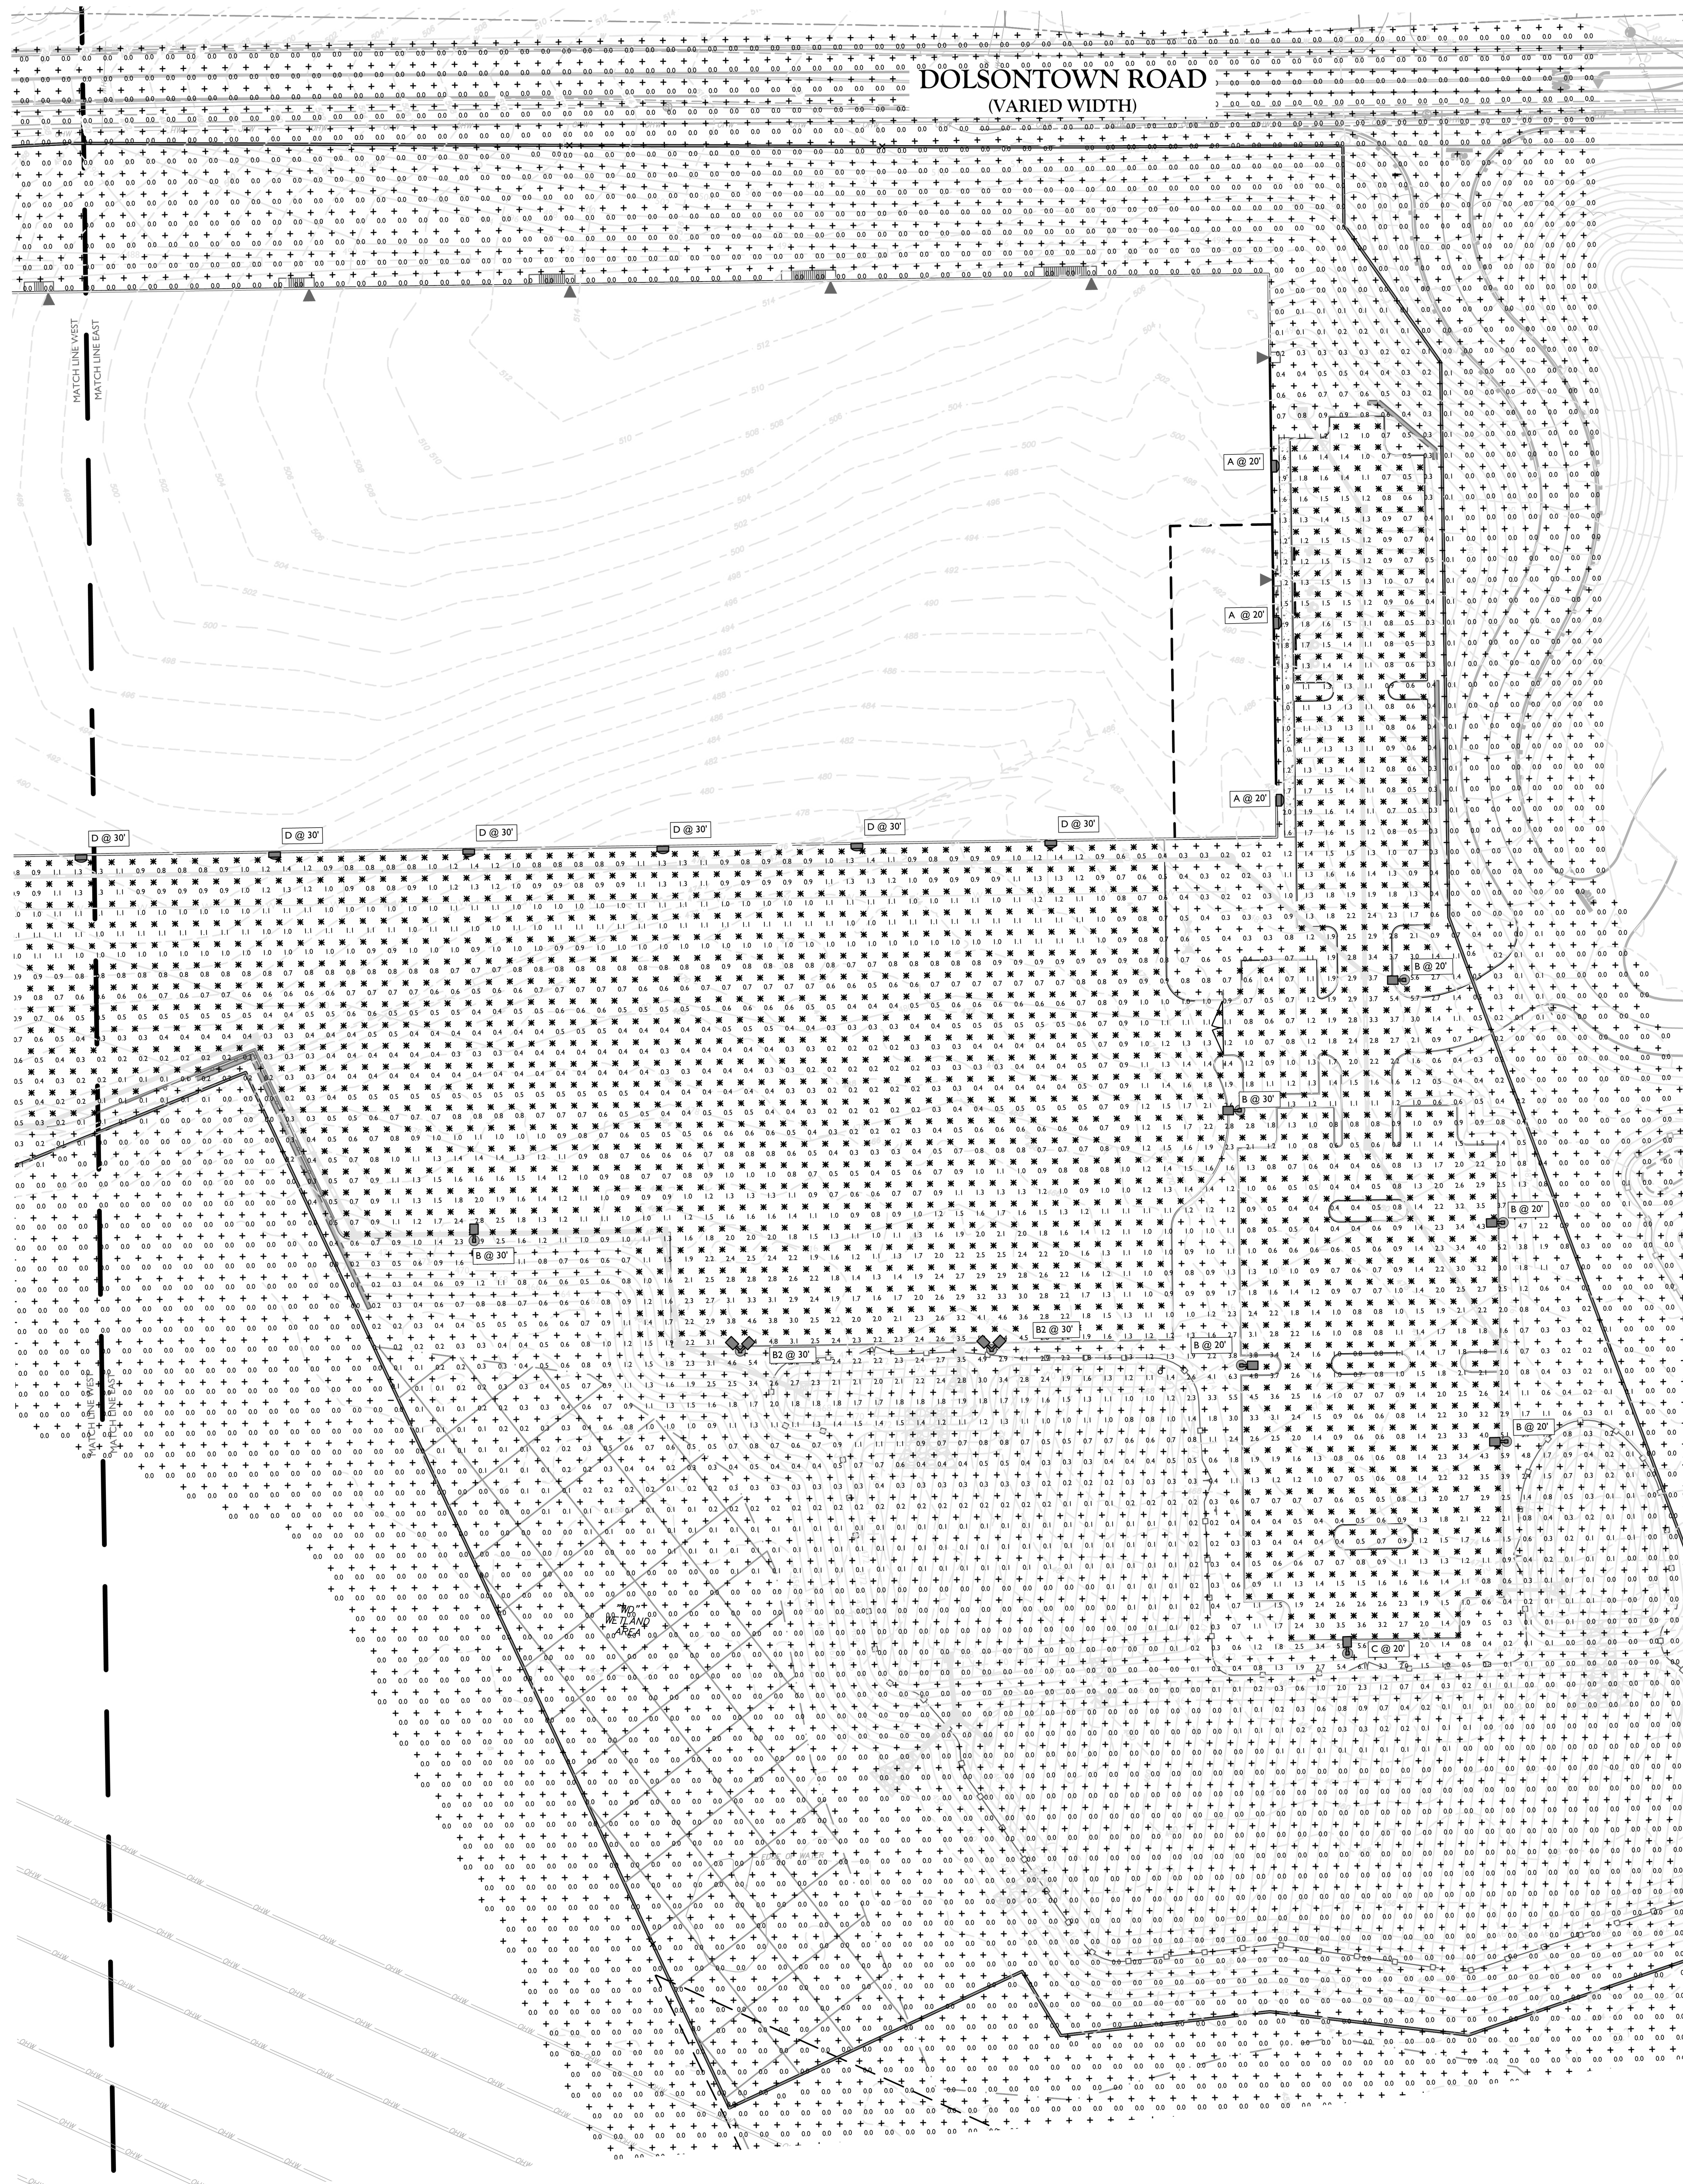
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SCALE: AS SHOWN DATE: 04/08/2024 DRAWN BY: MAS CHECKED BY: CDR
PROJECT NUMBER: 20096912E DRAWING NAME: C-4.GHT

SHEET TITLE: LIGHTING PLAN WEST

SHEET NUMBER: C-801

UNAUTHORIZED ALTERATION OR ADDITION TO A SURVEY OR ENGINEERING MAP BEARING A LICENSED LAND SURVEYOR OR PROFESSIONAL ENGINEER'S SEAL IS A VIOLATION OF SECTION 7209, SUB-DIVISION 2, OF THE NEW YORK STATE EDUCATION LAW. ONLY MAPS WITH THE LAND SURVEYOR OR PROFESSIONAL ENGINEER'S SEAL ARE GENUINE TRUE AND CORRECT COPIES OF THE LAND SURVEYOR OR PROFESSIONAL ENGINEER'S ORIGINAL WORK AND OPINION.



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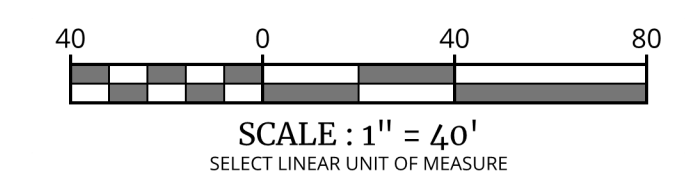
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FOR STATE SPECIFIC DIRECT PHONE NUMBERS VISIT WWW.CALL811.COM

LIGHTING LEGEND:

- ☐ SINGLE FIXTURE POLE LIGHT
- ▢ WALLPACK
- 0.0 LIGHT LEVEL AT GRADE (IN FOOTCANDLES)

LIGHTING NOTES:

1. THIS PLAN IS TO BE USED FOR LIGHTING PURPOSES ONLY.
2. POLES AND FIXTURES AS SUPPLIED BY:
POLES & WALL FIXTURES - HOLOPHANE
POLE FIXTURES - AMERICAN ELECTRIC LIGHTING
3. LAMPS ARE TO BE LED. A LIGHT LOSS FACTOR (LLF) WAS USED AS SHOWN IN THE LUMINAIRES SCHEDULE.
4. FIXTURES AND POLES ARE TO BE BLACK.
5. POLE MOUNTED FIXTURES SHALL BE PLACED A MINIMUM OF TWO (2) FEET BEHIND CURBS, EDGE OF PAVEMENT OR RETAINING WALLS IN CAR PARKING AREAS.
6. PROPOSED LIGHT FIXTURE LOCATIONS ARE CRITICAL TO PROVIDE THE LIGHTING LEVELS DEPICTED ON THIS PLAN. THE LIGHTING CONTRACTOR SHALL FIELD VERIFY FIXTURE LOCATIONS PRIOR TO INSTALLATION. IF ADJUSTMENT TO ANY LIGHT FIXTURE LOCATION IS REQUIRED DUE TO FINAL CONSTRUCTION OF UTILITIES AND SITE IMPROVEMENTS, THE LIGHTING CONTRACTOR SHALL NOTIFY THE PROJECT LANDSCAPE ARCHITECT OF ANY DISCREPANCIES PRIOR TO INSTALLATION.
7. LIGHTING SHOWN ON PLAN DEPICTS AVERAGE MAINTAINED FOOTCANDLE LEVELS AT GRADE.
8. CONTRACTOR TO PROVIDE SHOP DRAWINGS OF LIGHT FIXTURES FOR REVIEW AND APPROVAL BY THE OWNER OR PROJECT LANDSCAPE ARCHITECT.
9. ELECTRICAL PLANS FOR WIRING LAYOUT BY OTHERS.
10. POLE BASE INSTALLATION SHALL INCLUDE A SUPPLEMENTARY GROUND ROD AND WIRE LEAD TO BASE FOR POWER CONNECTION. DETAILS PER PROJECT ELECTRICAL ENGINEER.
11. ALL LIGHTING FIXTURES WILL BE DARK SKY COMPLIANT.



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Digitally signed by Justin E. Dates
Date: 2024.04.08 12:08:27 -0400

Justin Eric Dates
NEW YORK REGISTERED LANDSCAPE ARCHITECT
LICENSE NUMBER: 001964-01
COLLIERS ENGINEERING & DESIGN CT, P.C.

PRELIMINARY SITE PLAN
FOR
DEWPOINT SOUTH
SBL: 4-1-50.32, 6-1-90.22,
90.24 & 107
TOWN OF WAWAYANDA
ORANGE COUNTY
NEW YORK STATE


Colliers 555 Hudson Valley Avenue
Suite 101
New Windsor, NY 12553
Phone: 945.564.4499
COLLIERS ENGINEERING & DESIGN
ARCHITECTURAL, LANDSCAPE ARCHITECTURE,
SURVEYING CT, P.C.

SCALE: DATE: DRAWN BY: CHECKED BY:
AS SHOWN: 04/08/2024 MAS CDR
PROJECT NUMBER: DRAWING NAME:
20006912E C-4.GHT

SHEET TITLE:
LIGHTING PLAN
EAST
SHEET NUMBER:
C-802


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NOTE: DO NOT SCALE DRAWINGS FOR CONSTRUCTION.

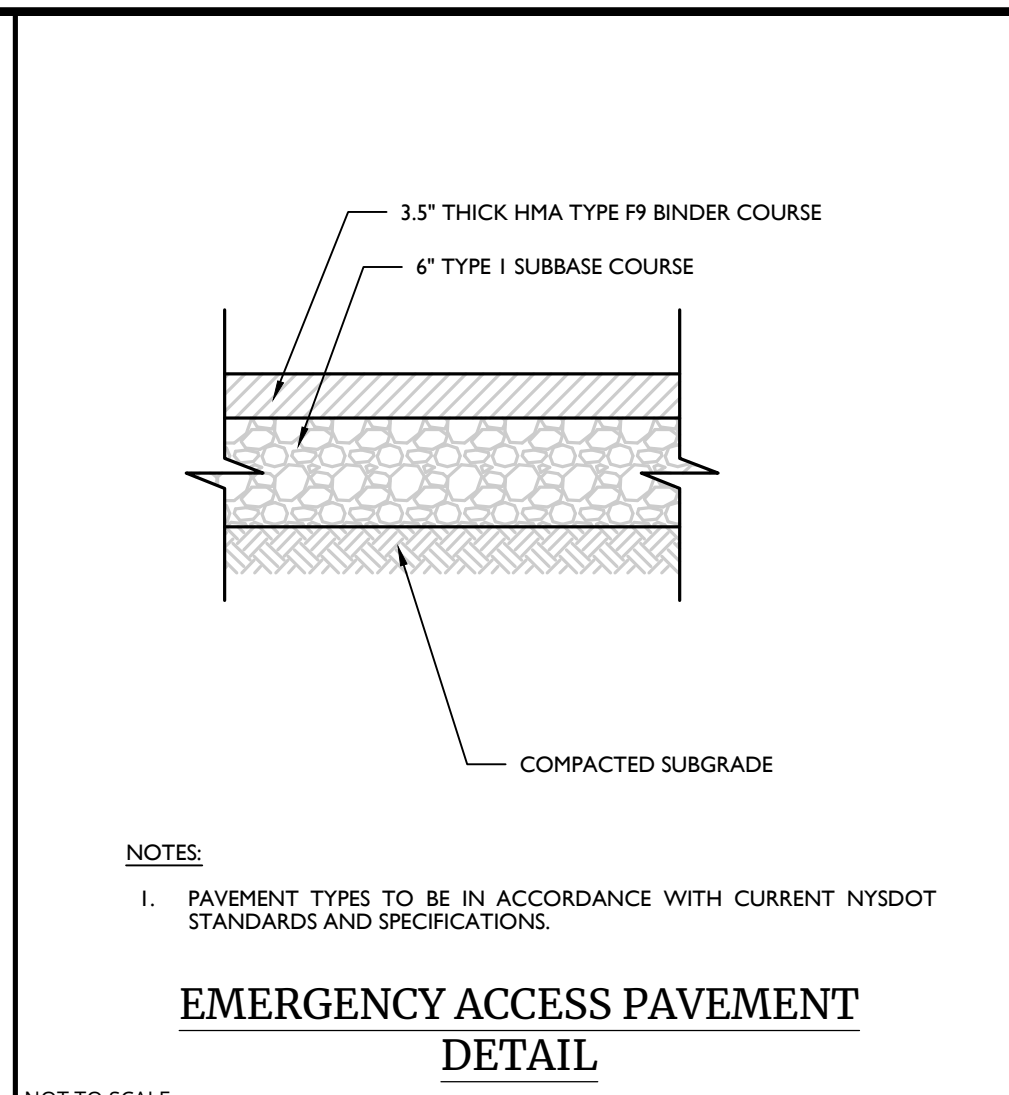


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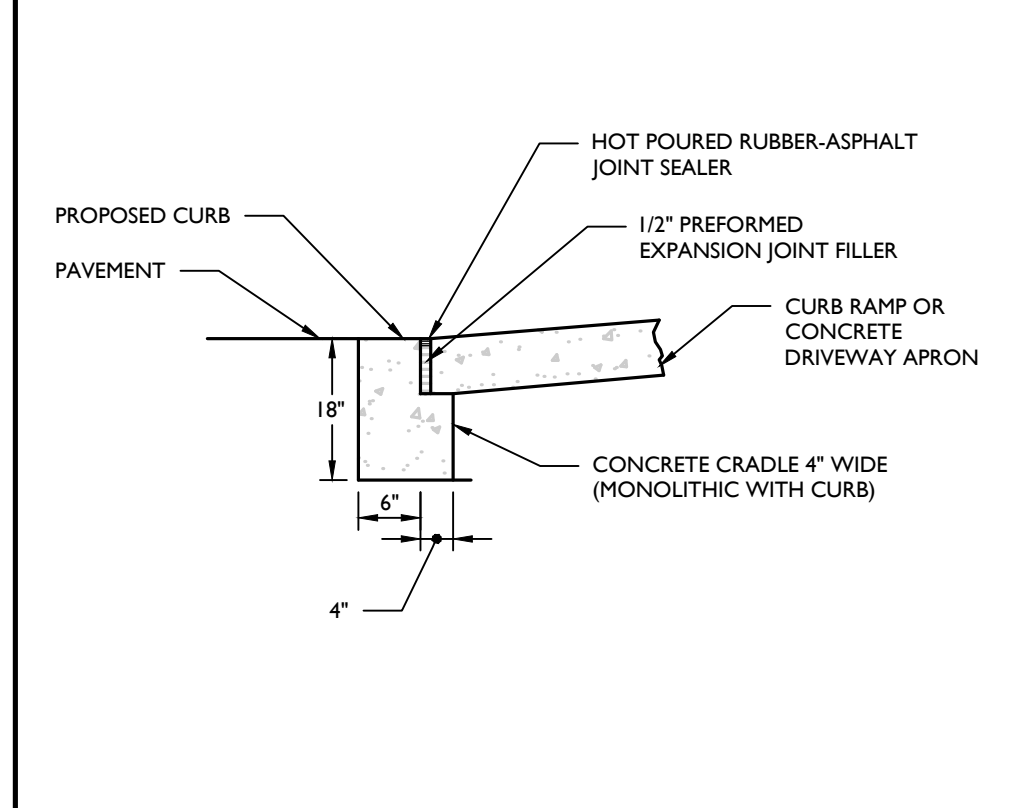
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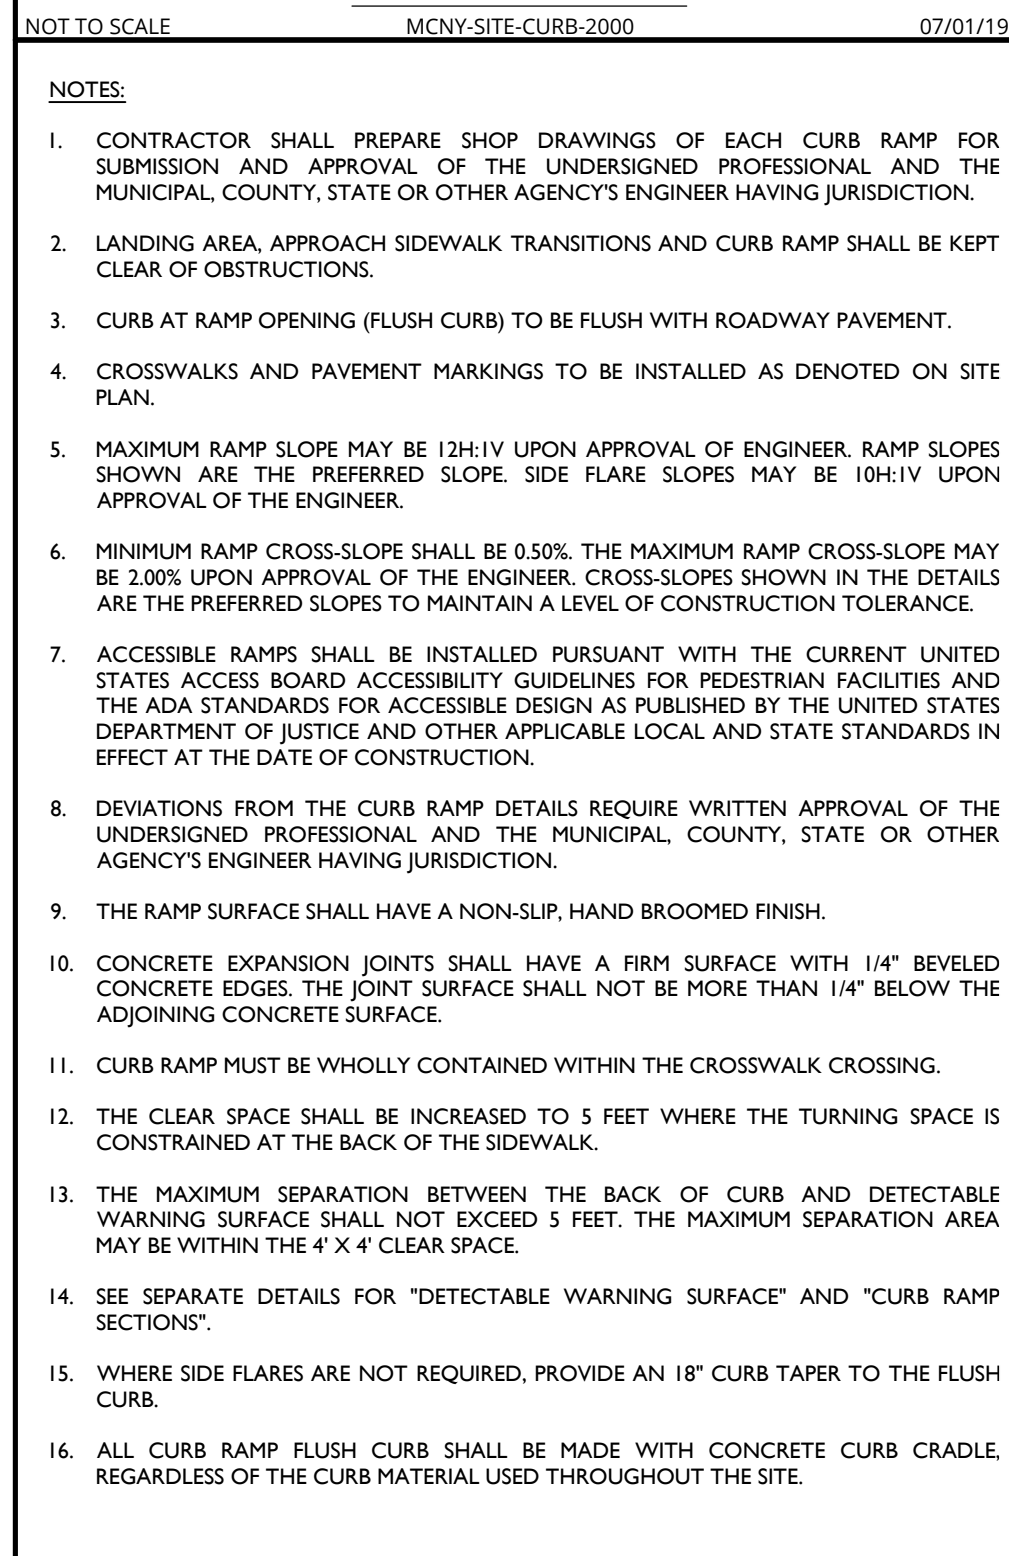
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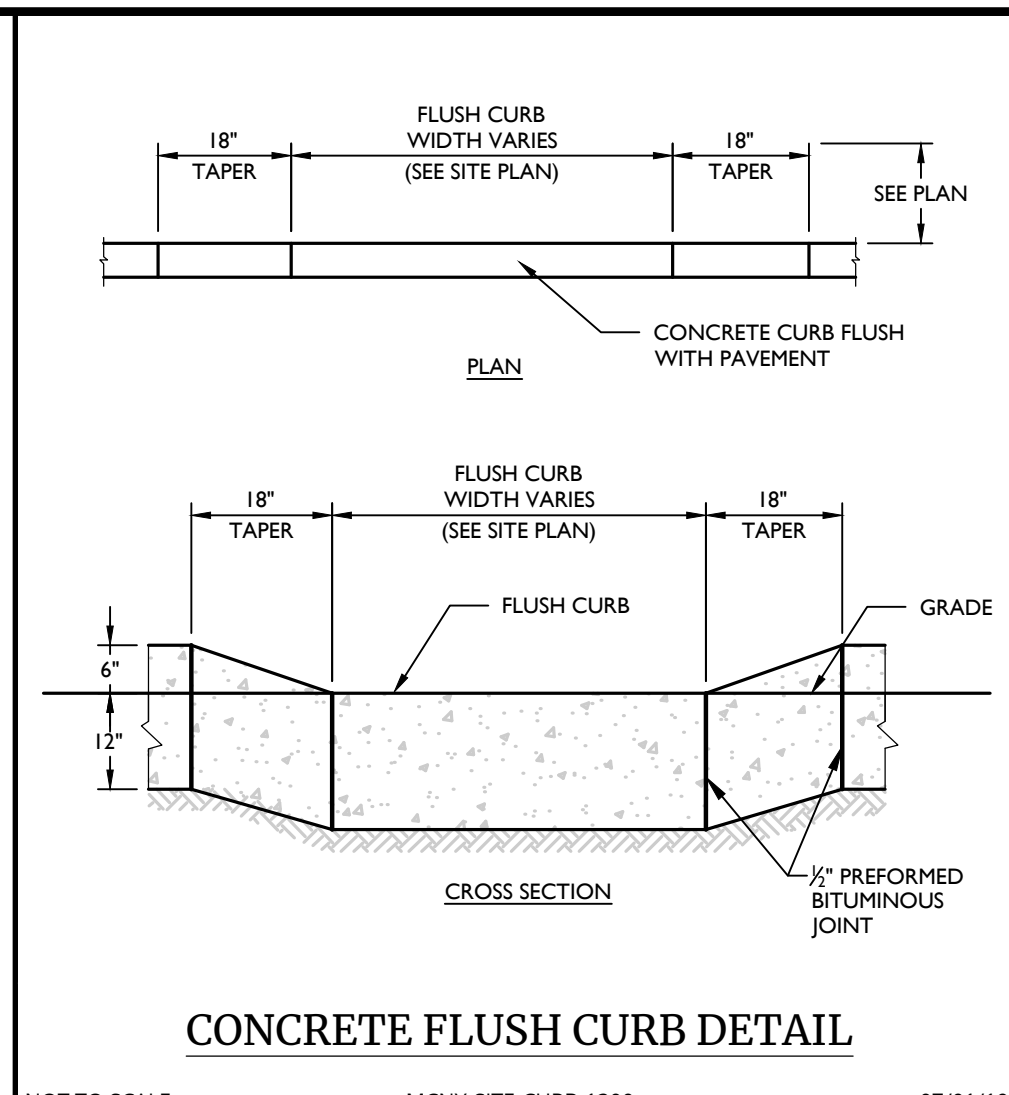
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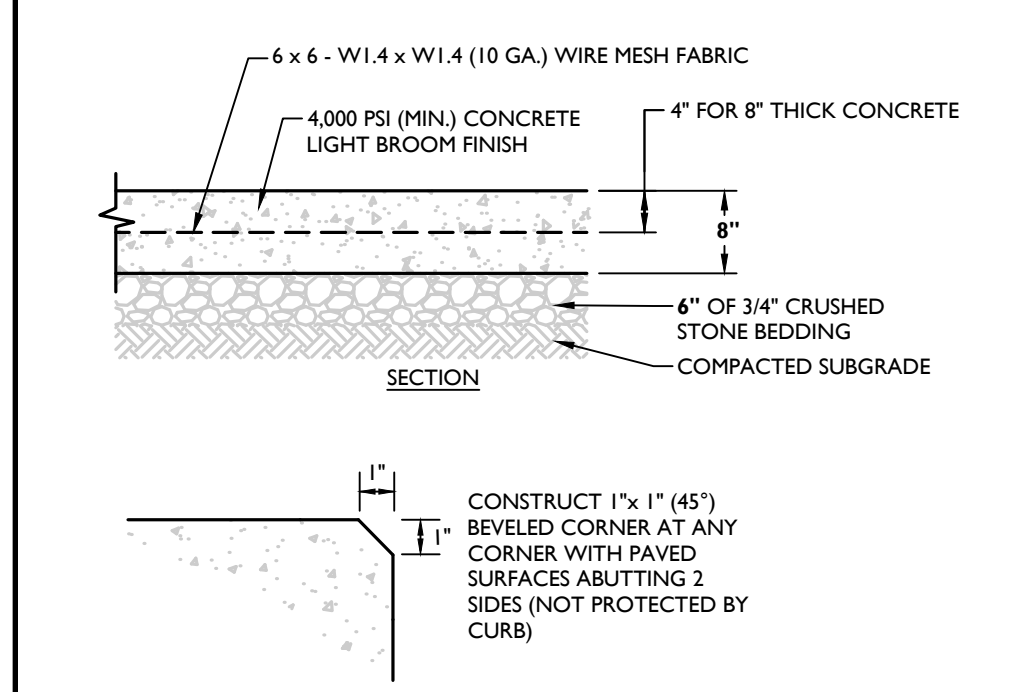
CURB RAMP NOTES

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CONCRETE FLUSH CURB DETAIL

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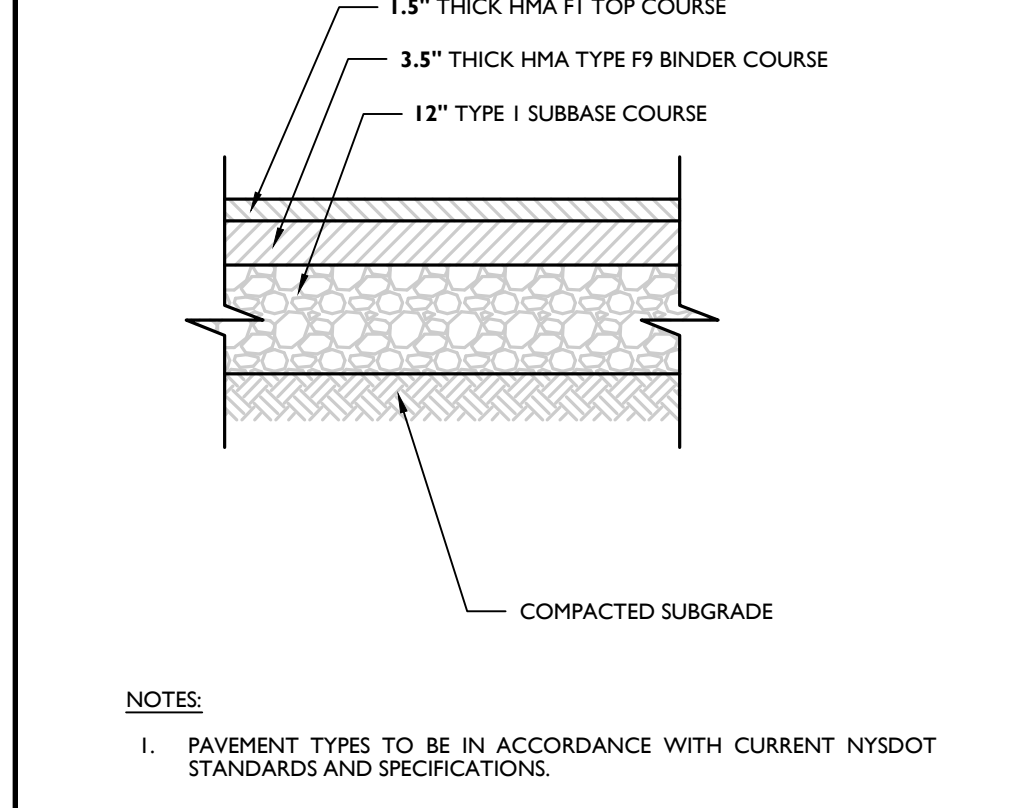
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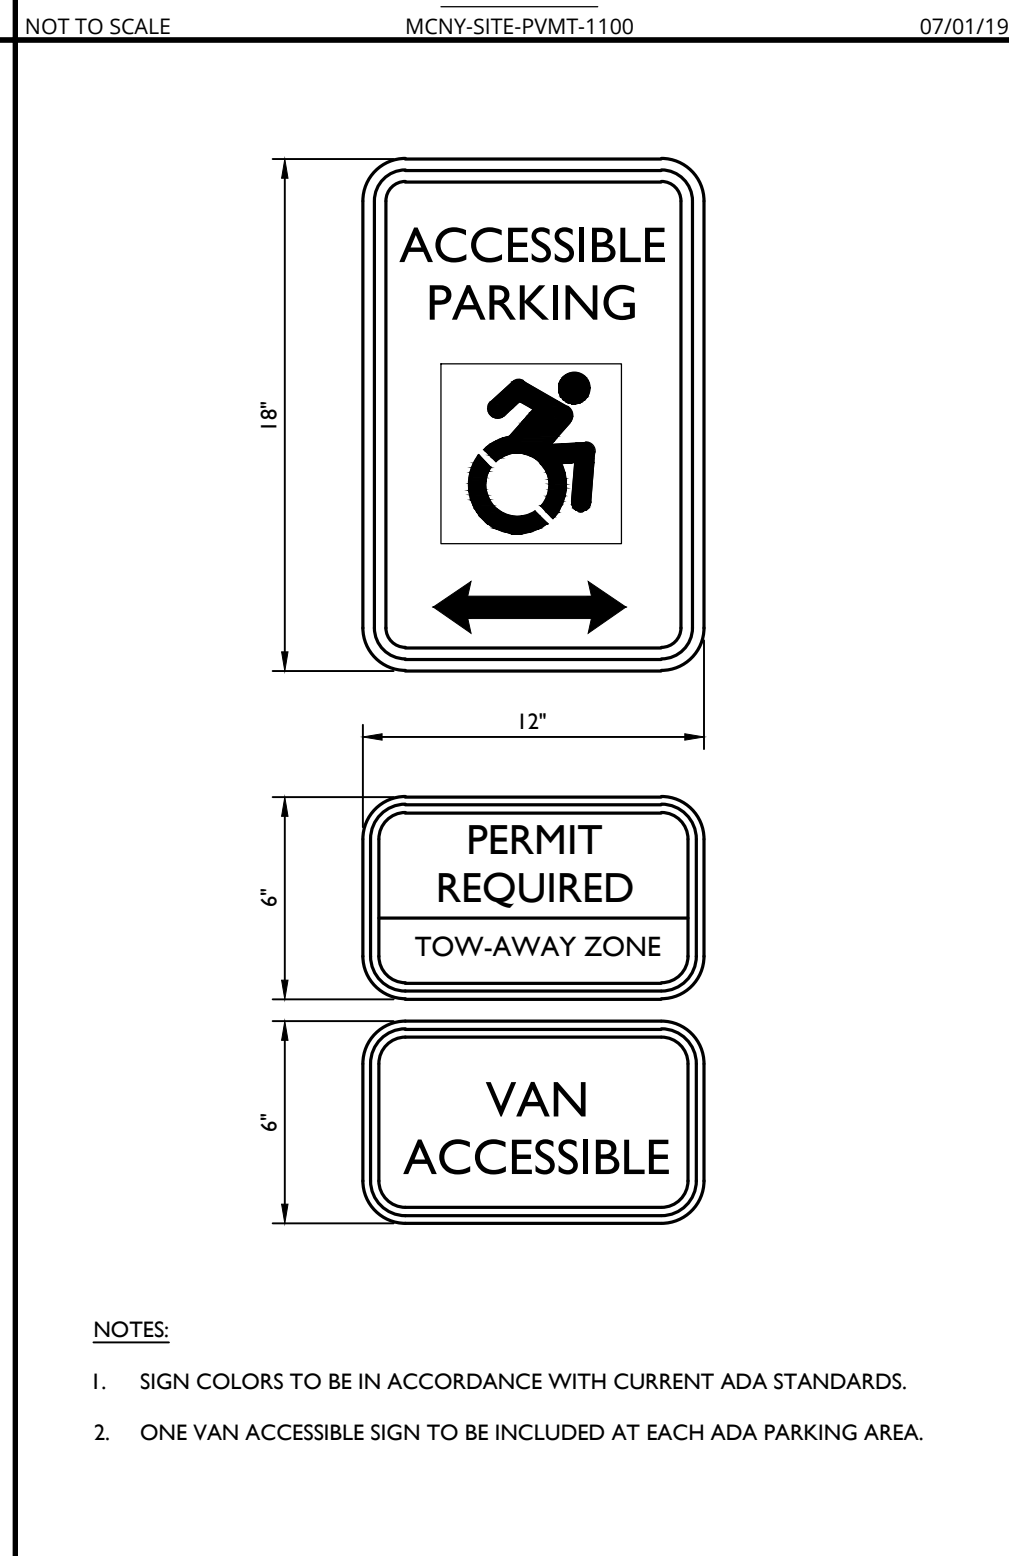
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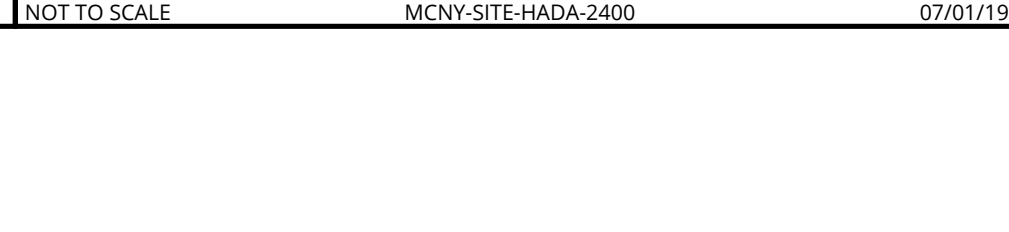
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NOT TO SCALE

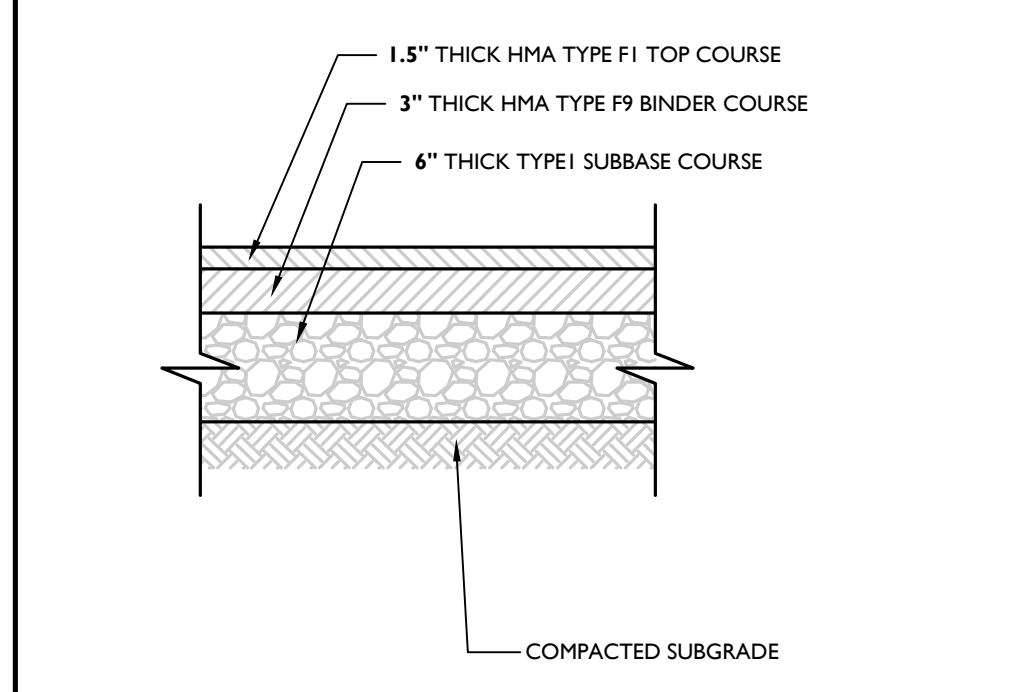

R8-4 SIGN DETAIL
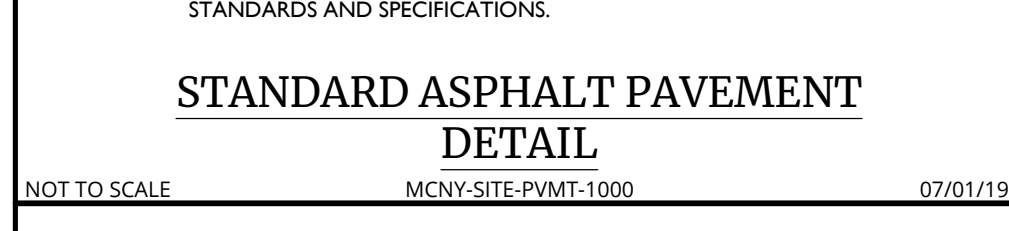
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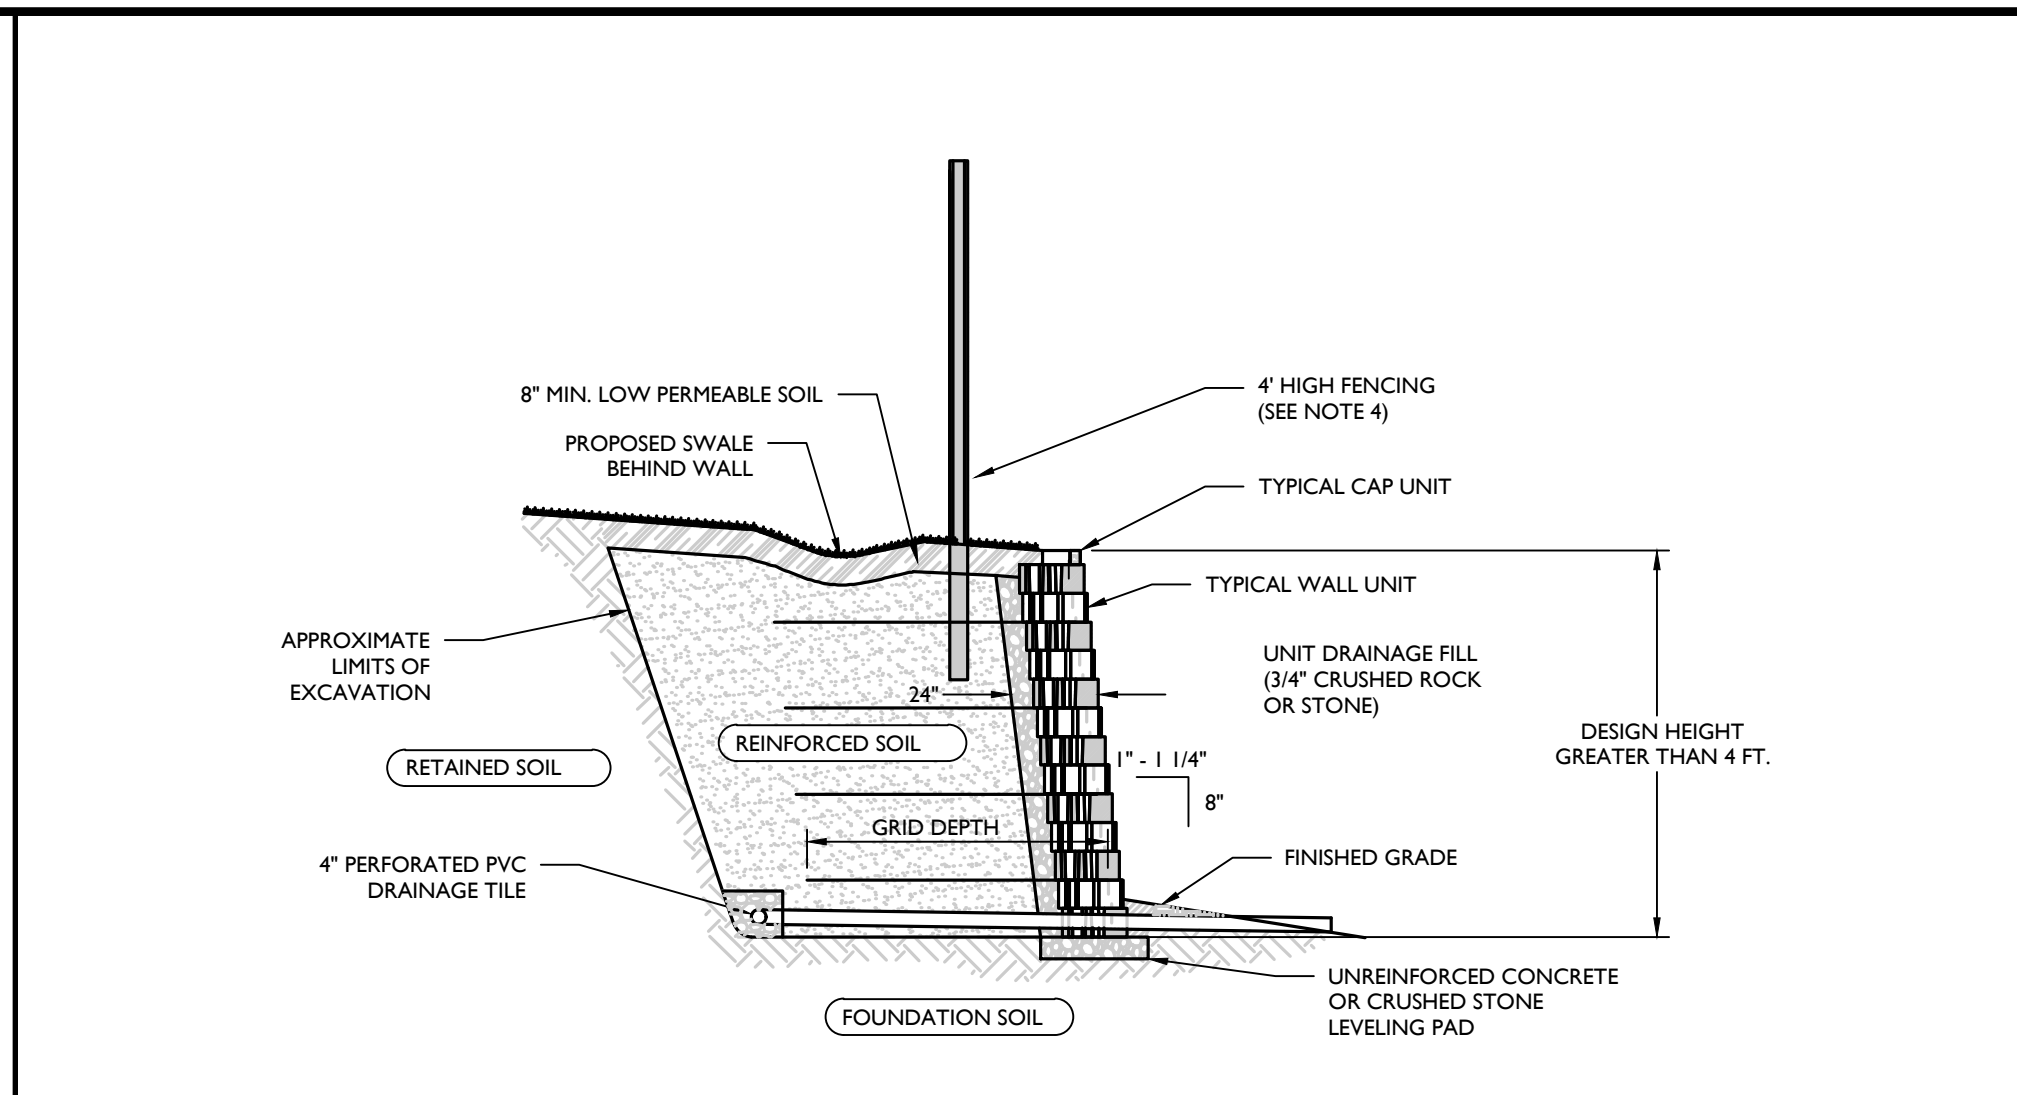
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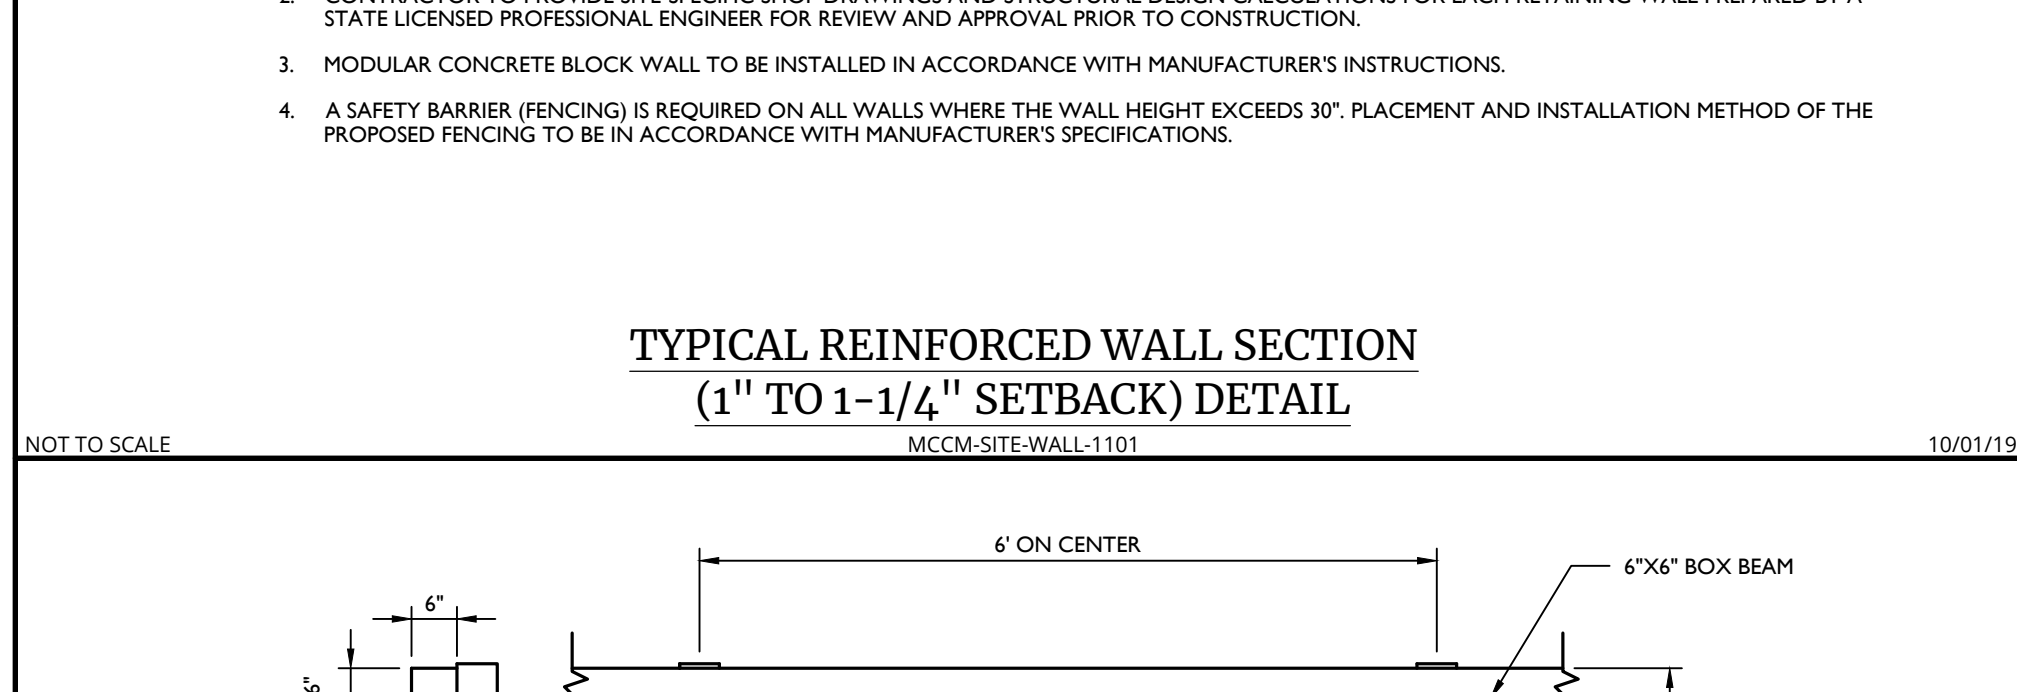
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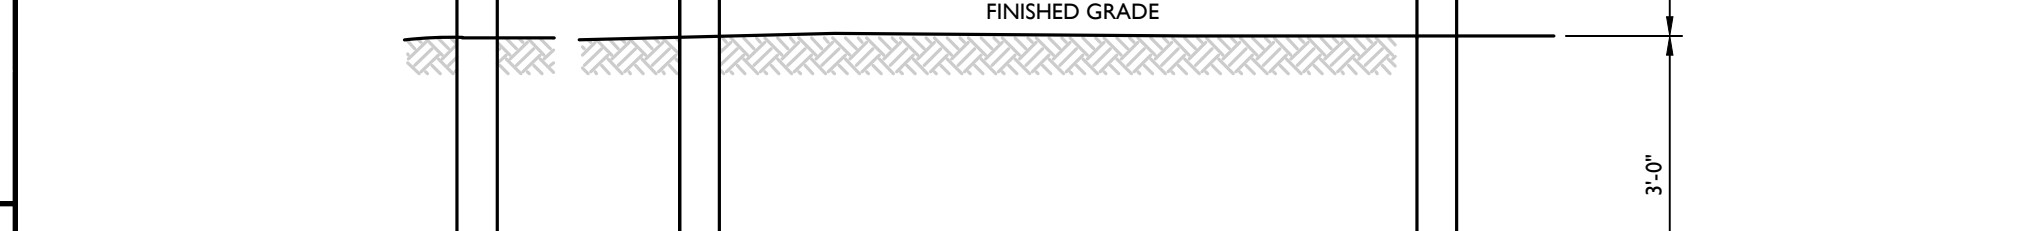
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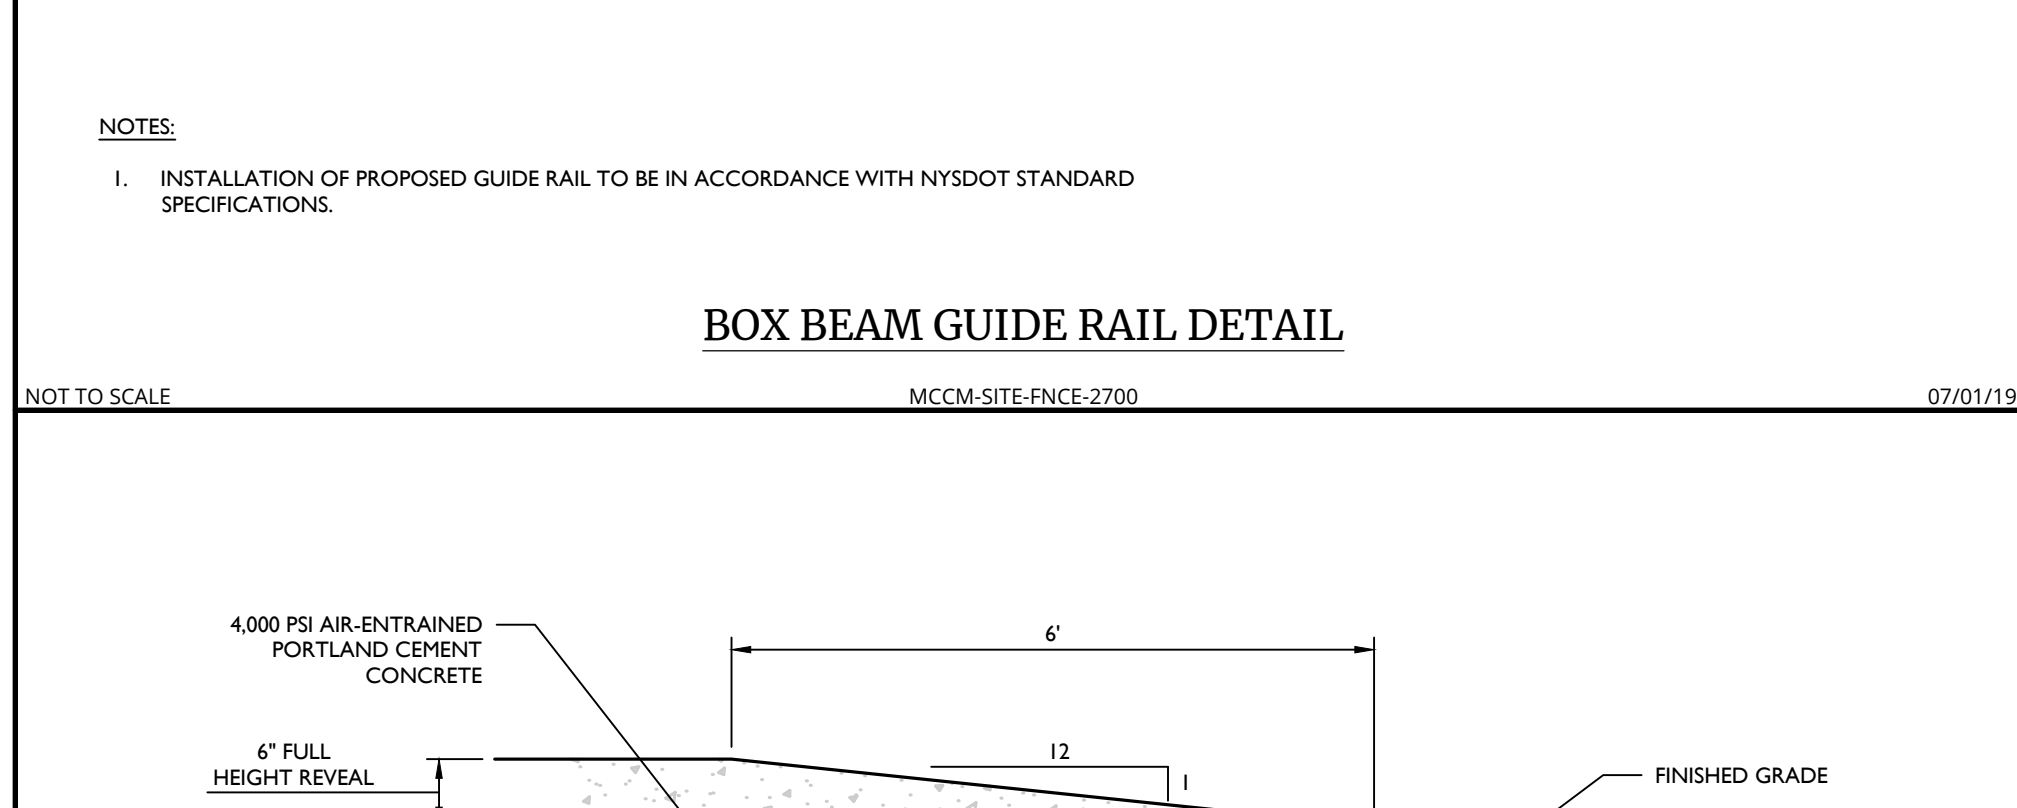
BOX BEAM GUIDE RAIL DETAIL

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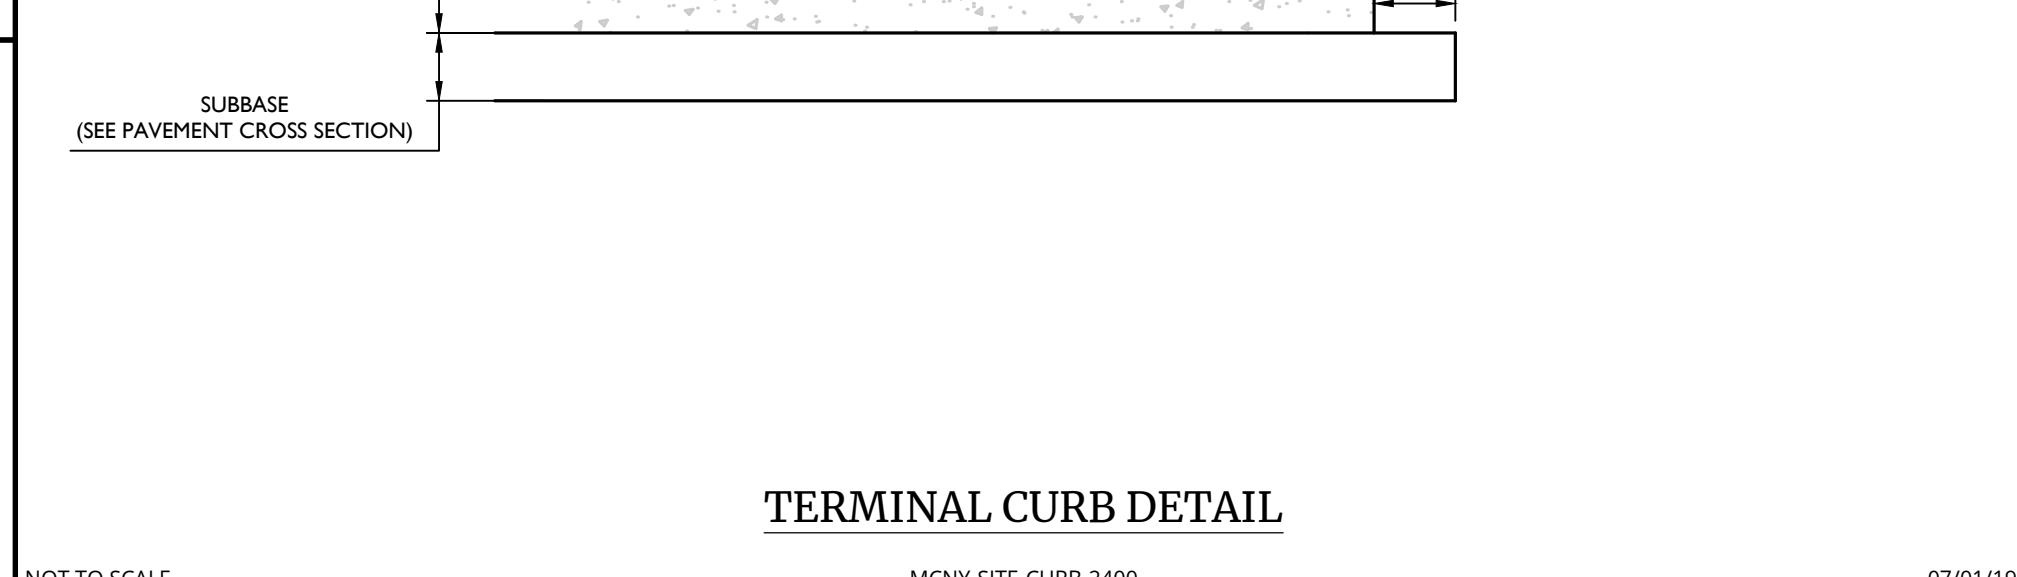
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NOT TO SCALE




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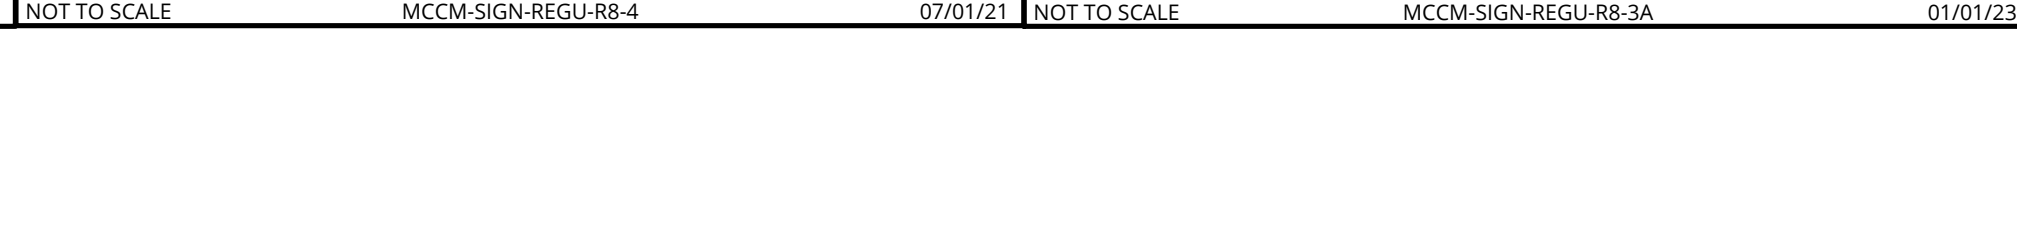
CONCRETE CURB (ASPHALT PAVEMENT) DETAIL

NOT TO SCALE



CURB RAMP TYPE 7 DETAIL

NOT TO SCALE

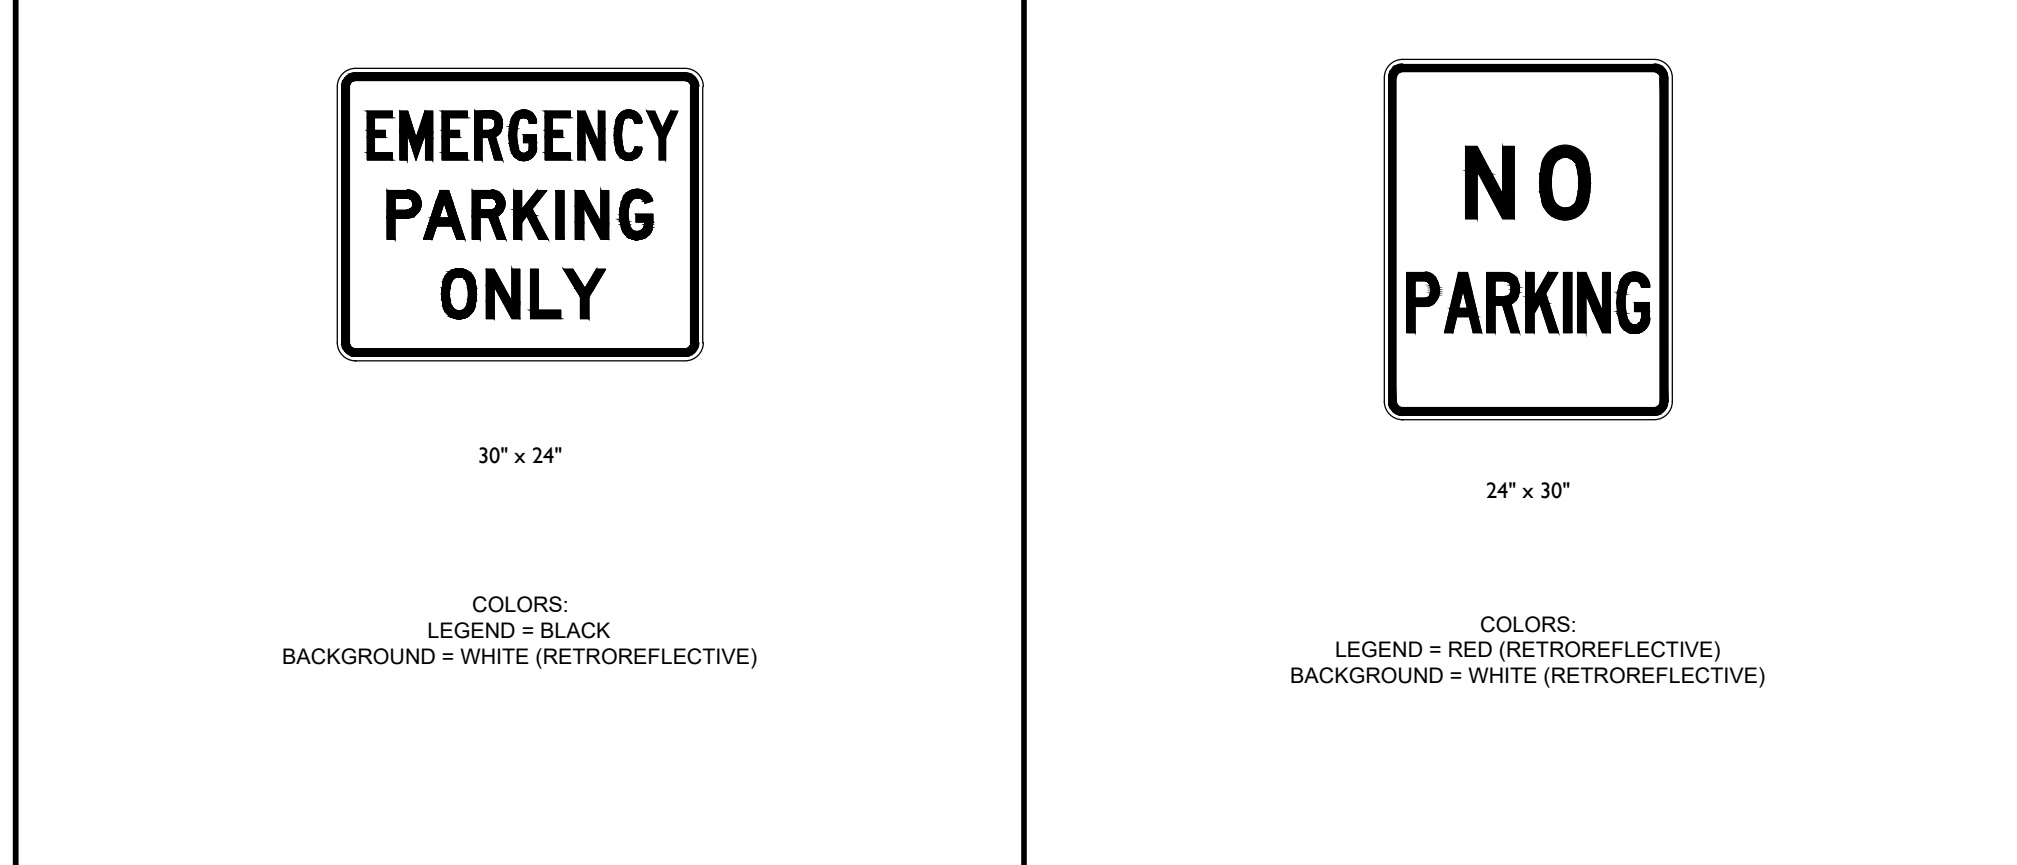


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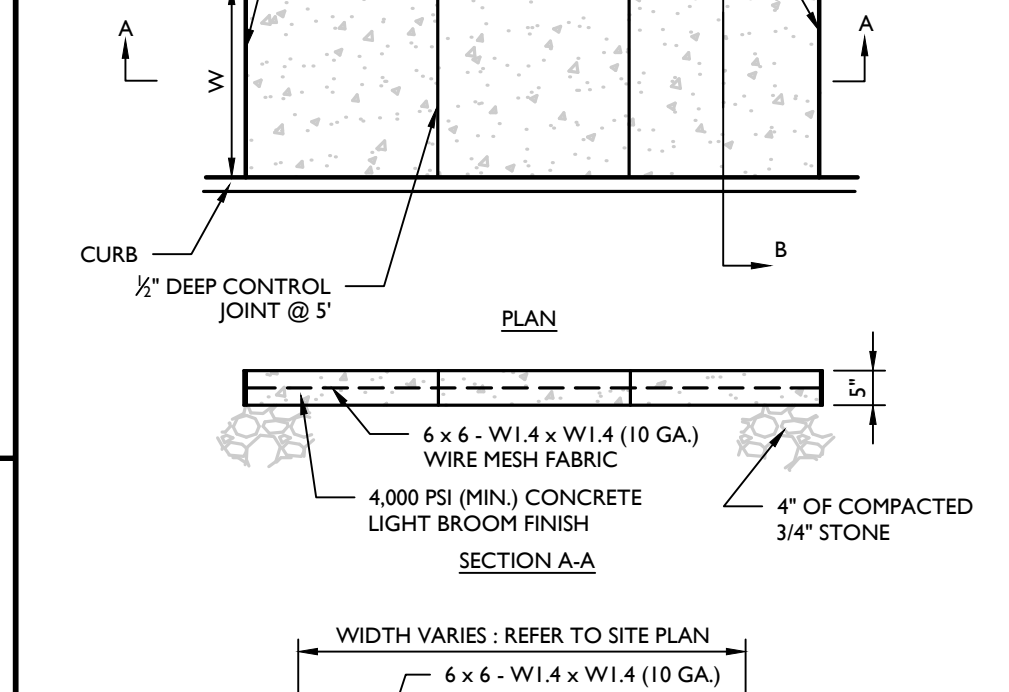
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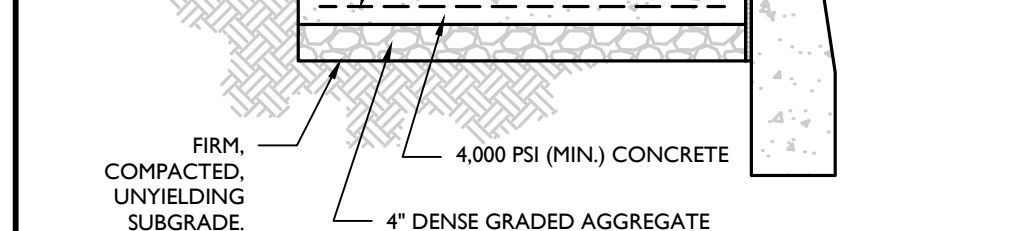
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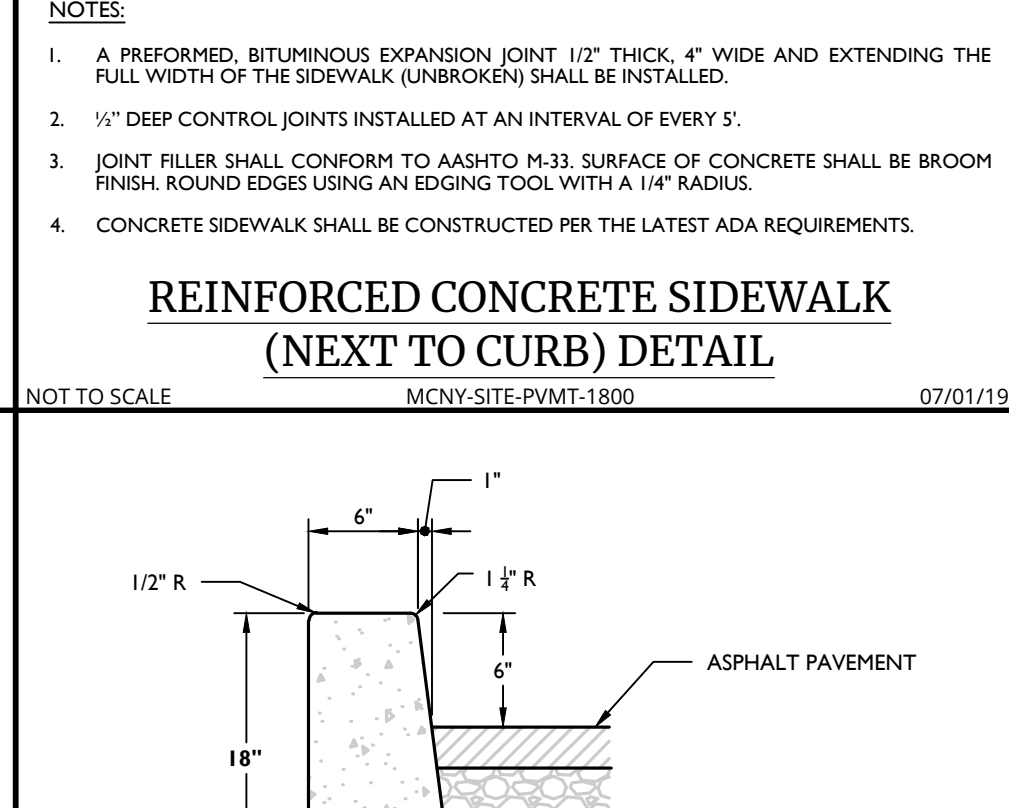
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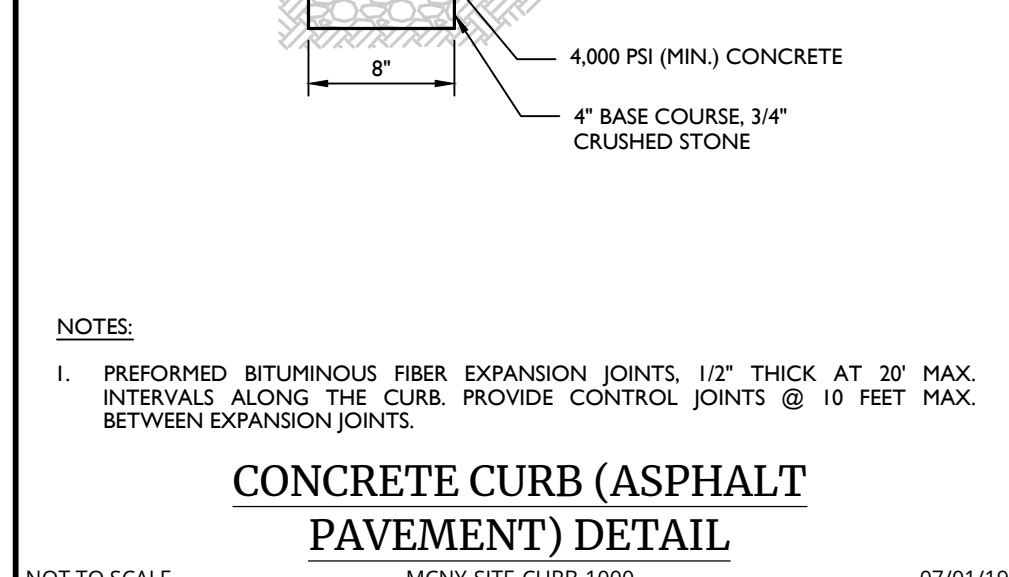
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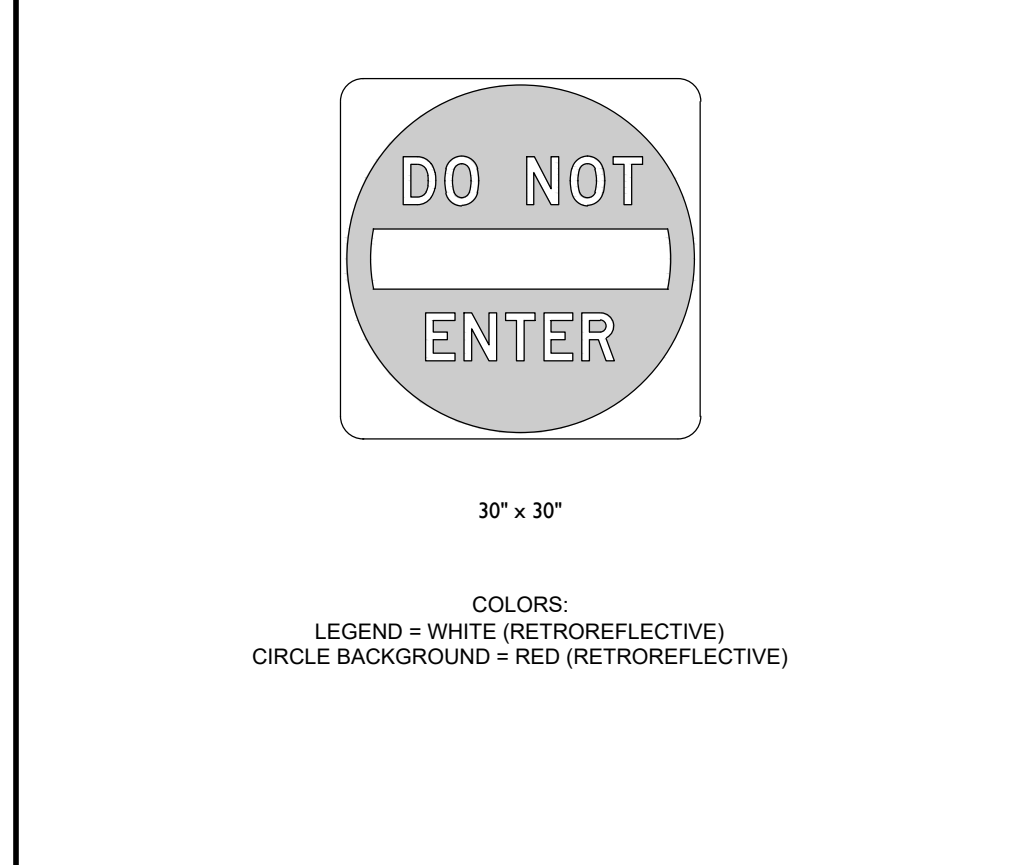
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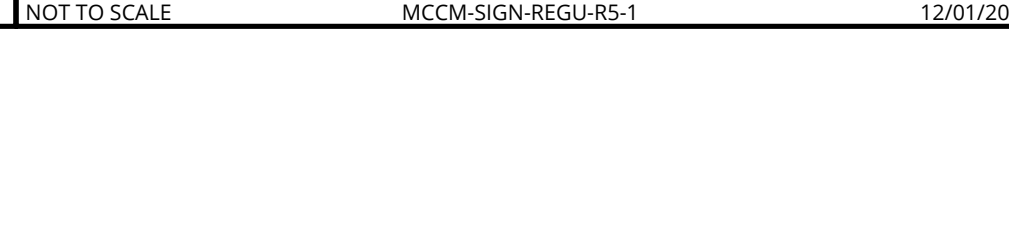
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EMERGENCY ACCESS PAVEMENT DETAIL

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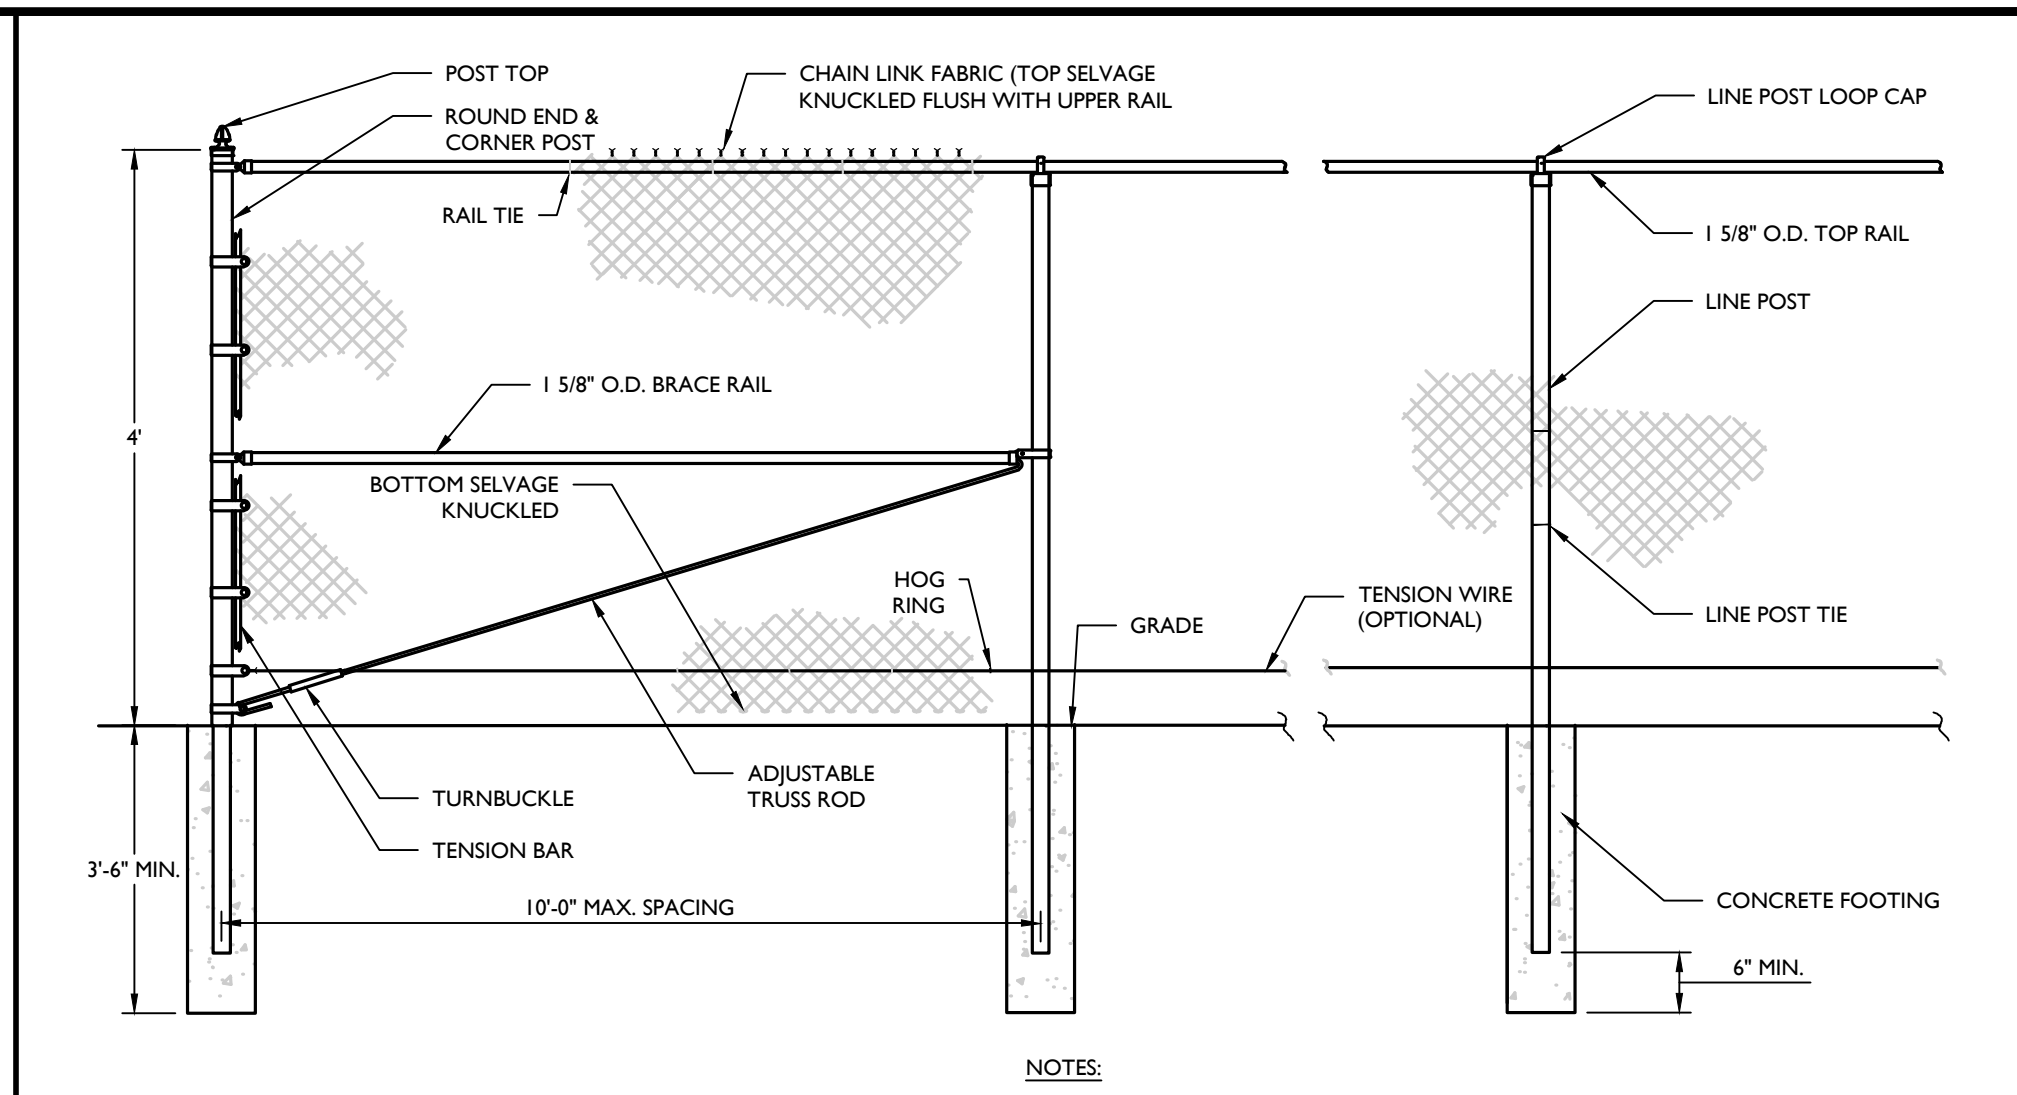
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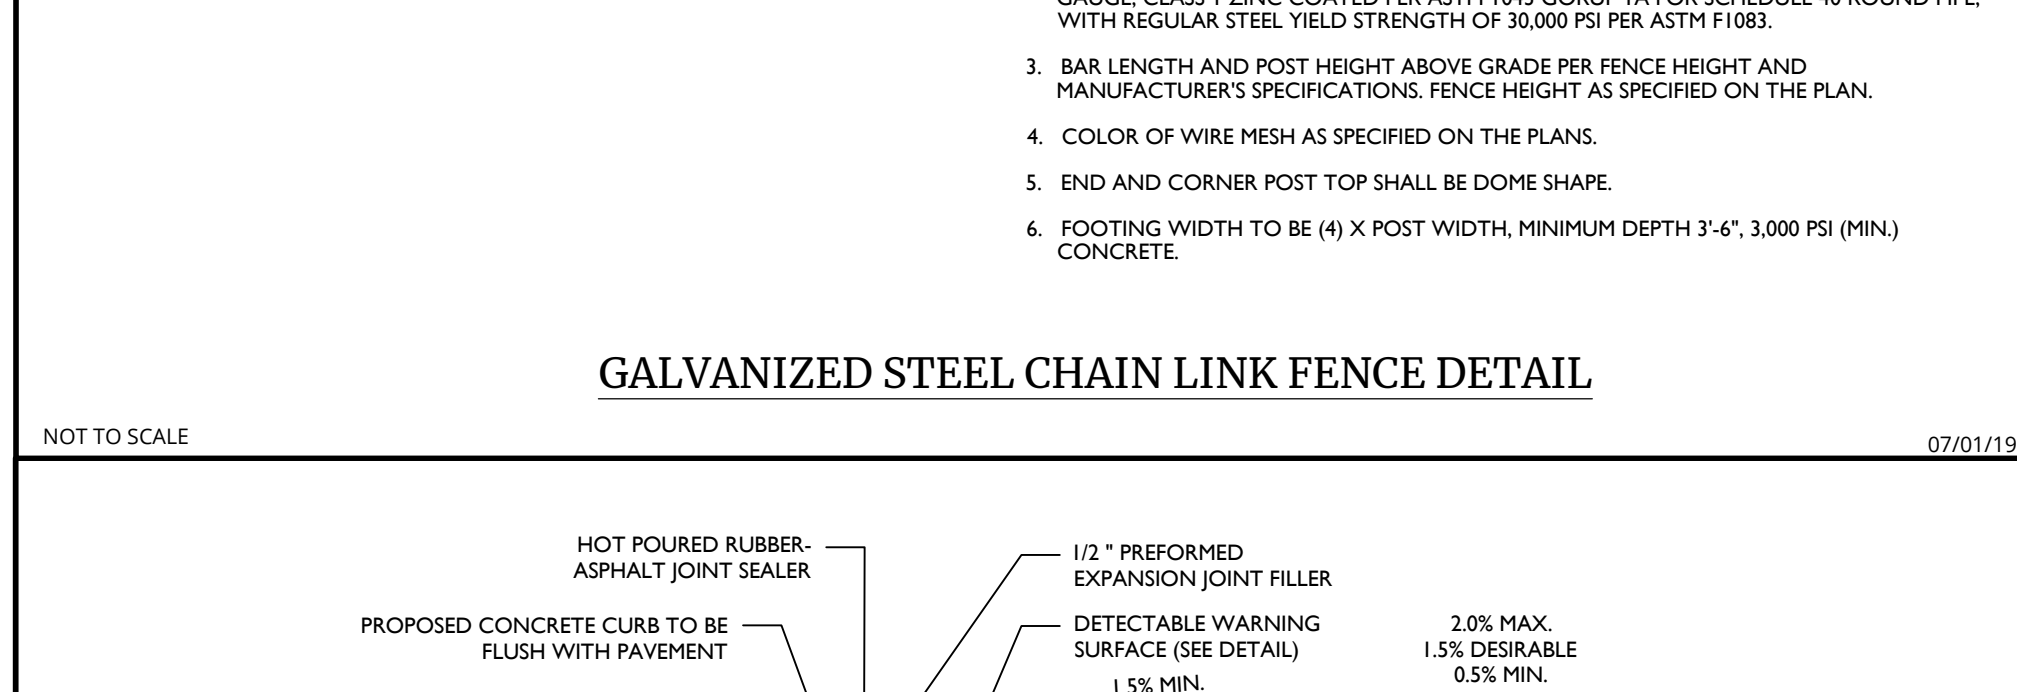
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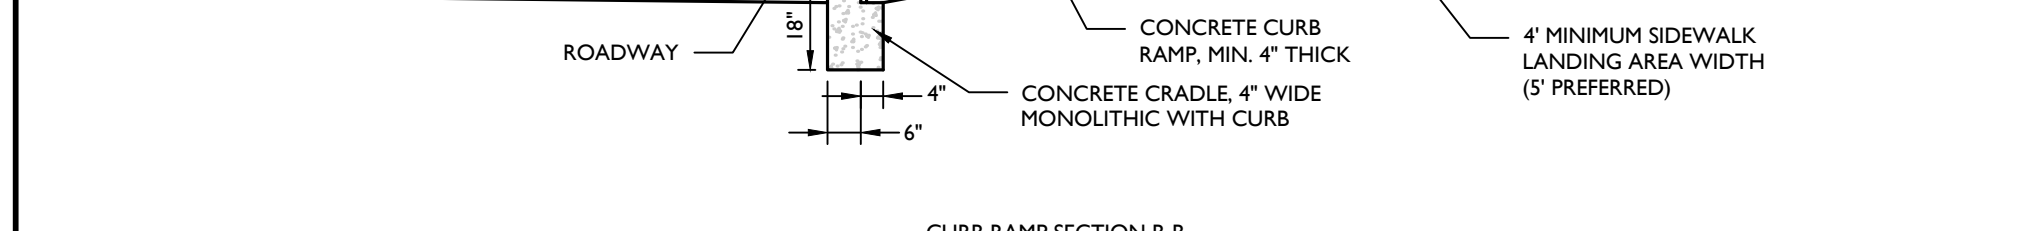
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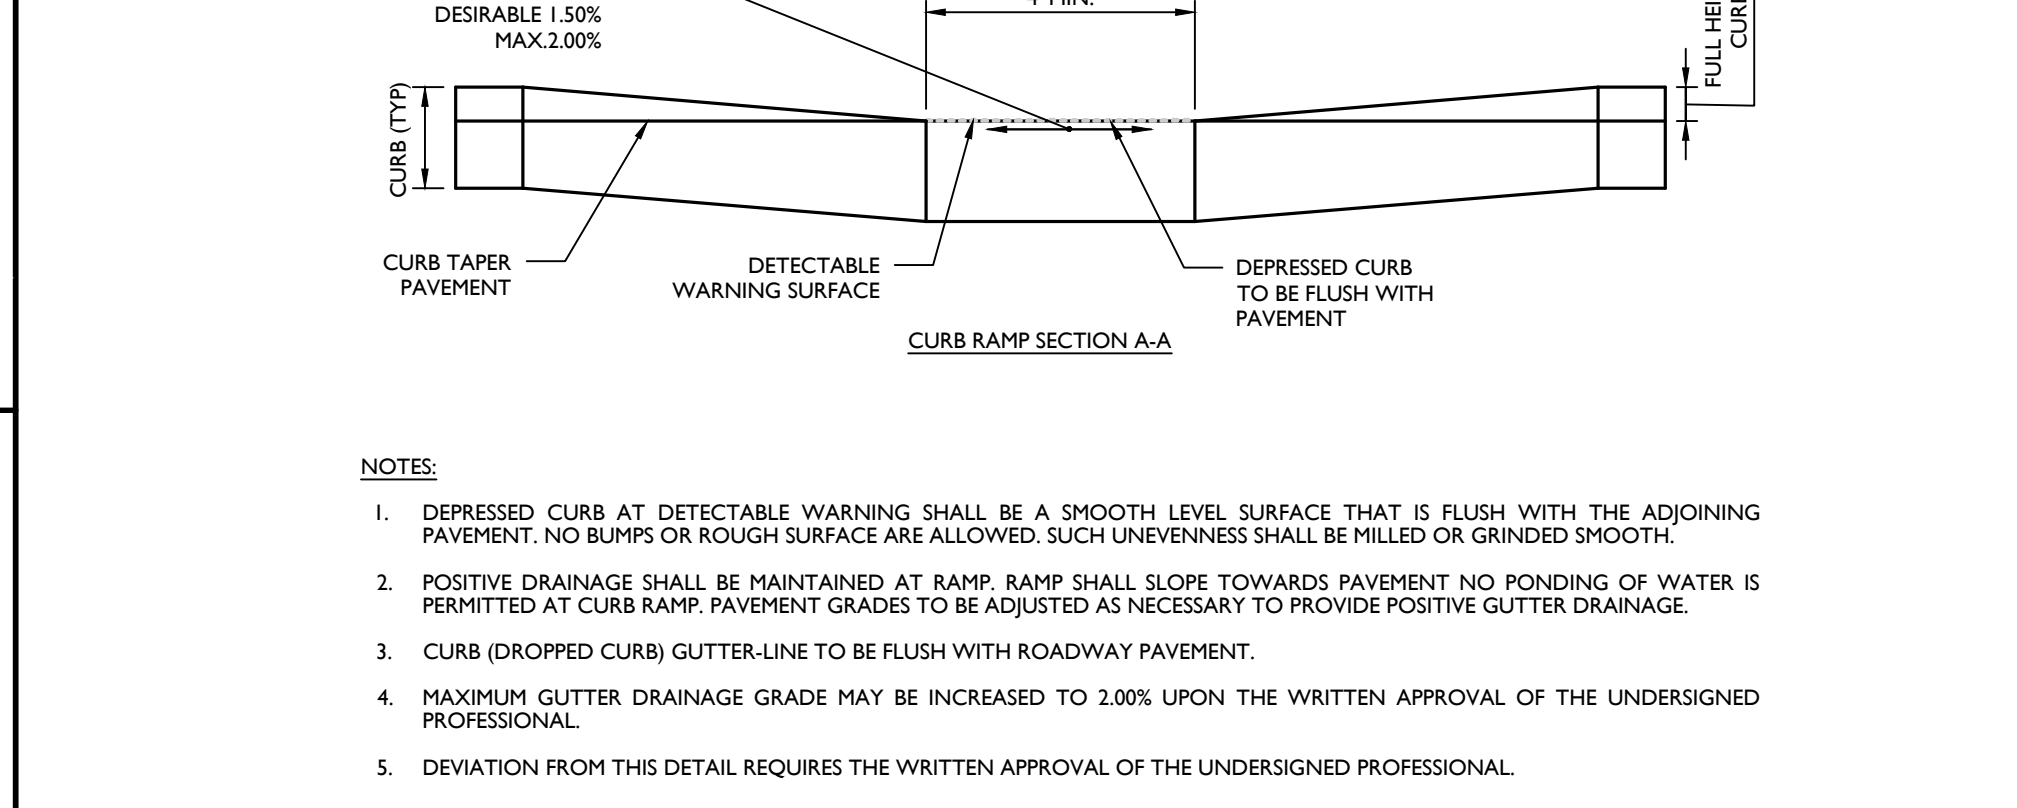
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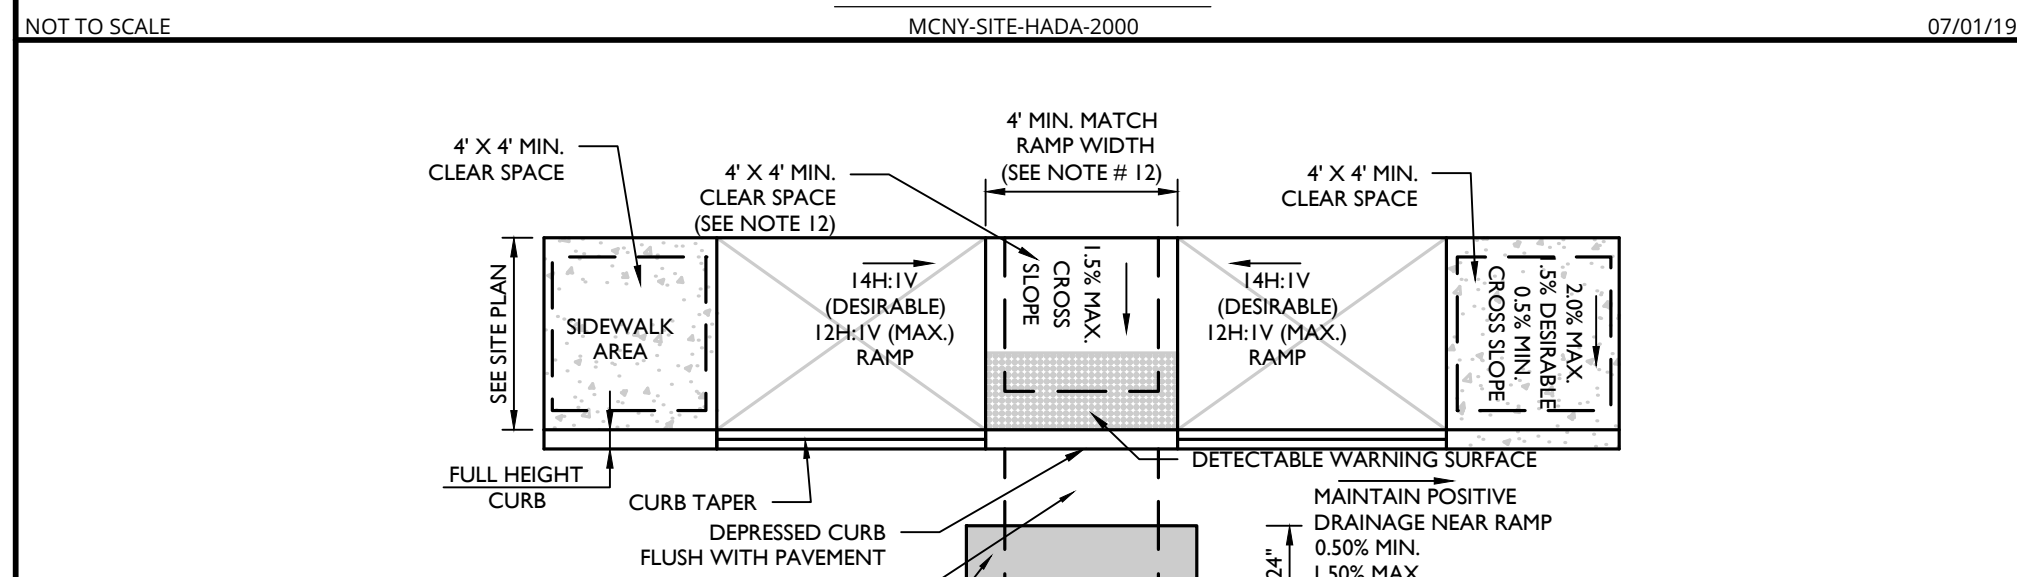
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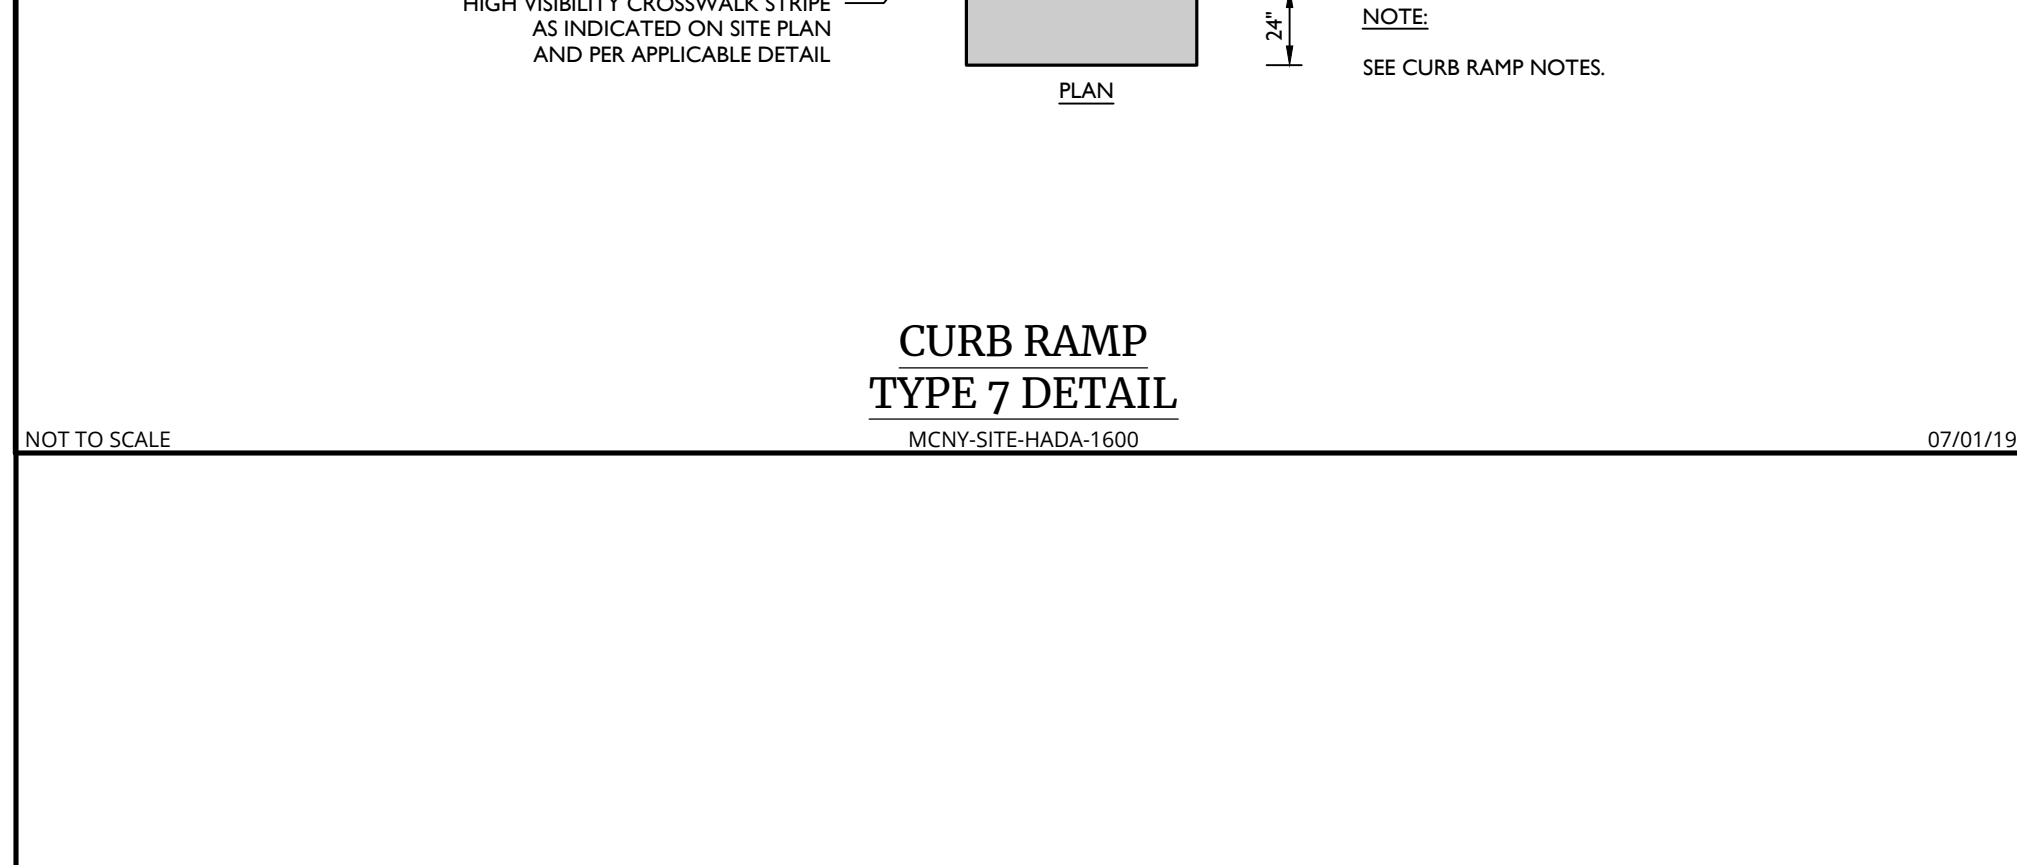
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SPLIT RAIL FENCE (2 - RAIL) DETAIL

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GALVANIZED STEEL CHAIN LINK FENCE DETAIL

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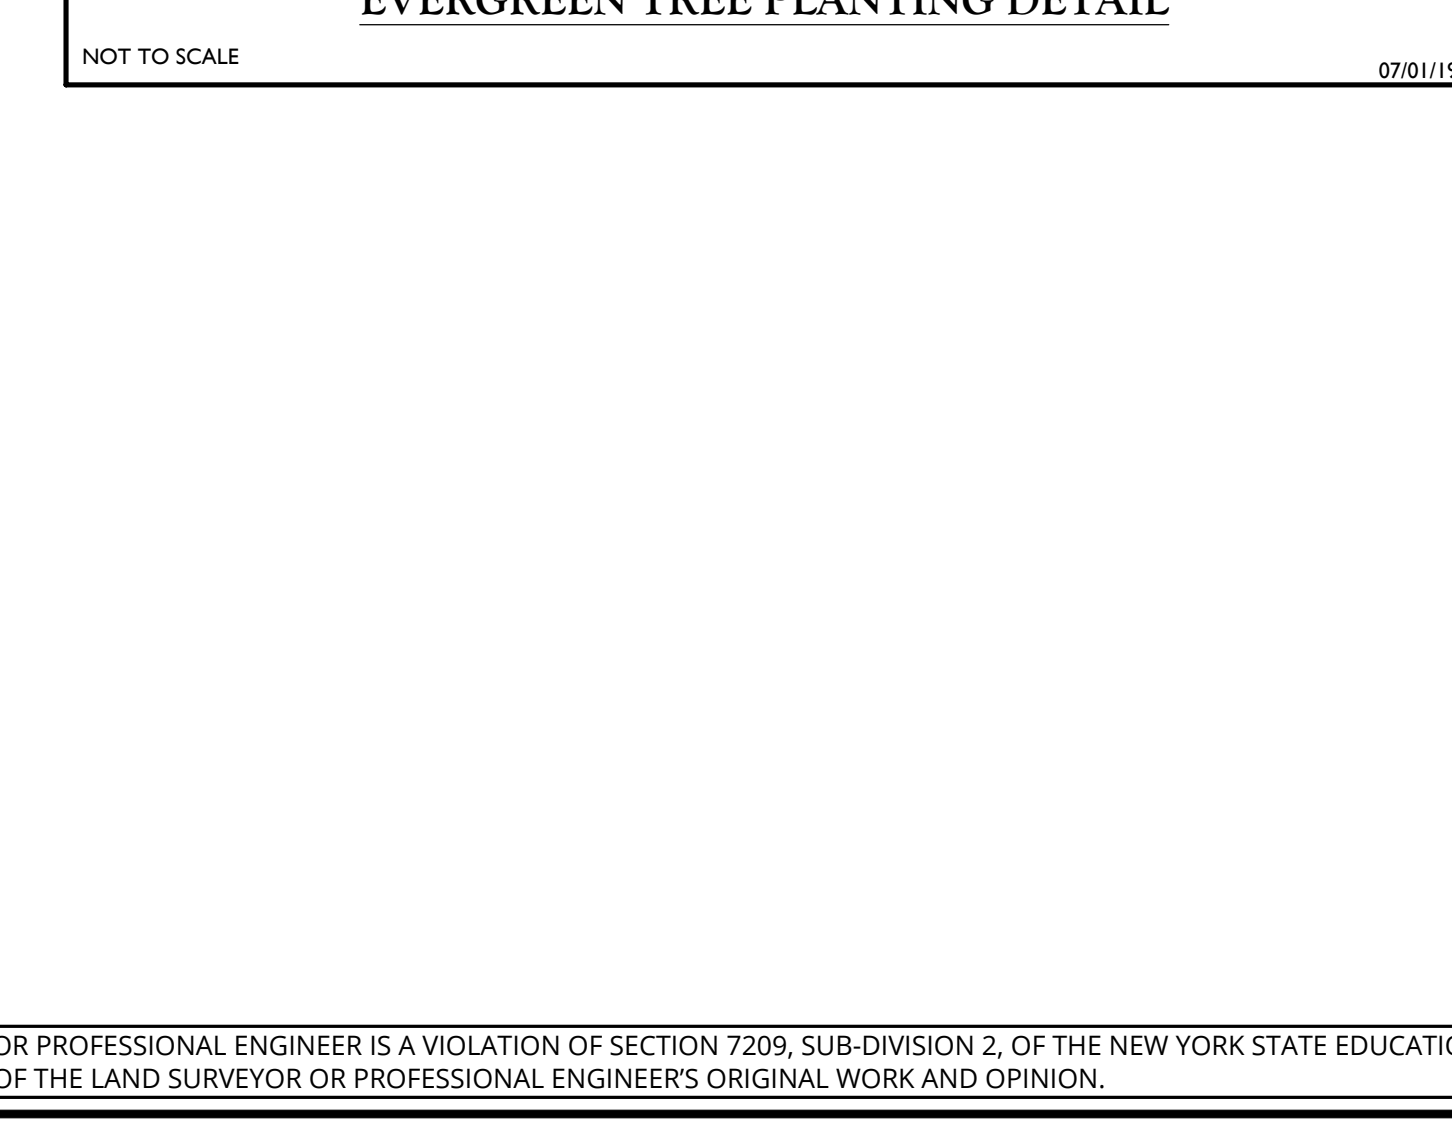
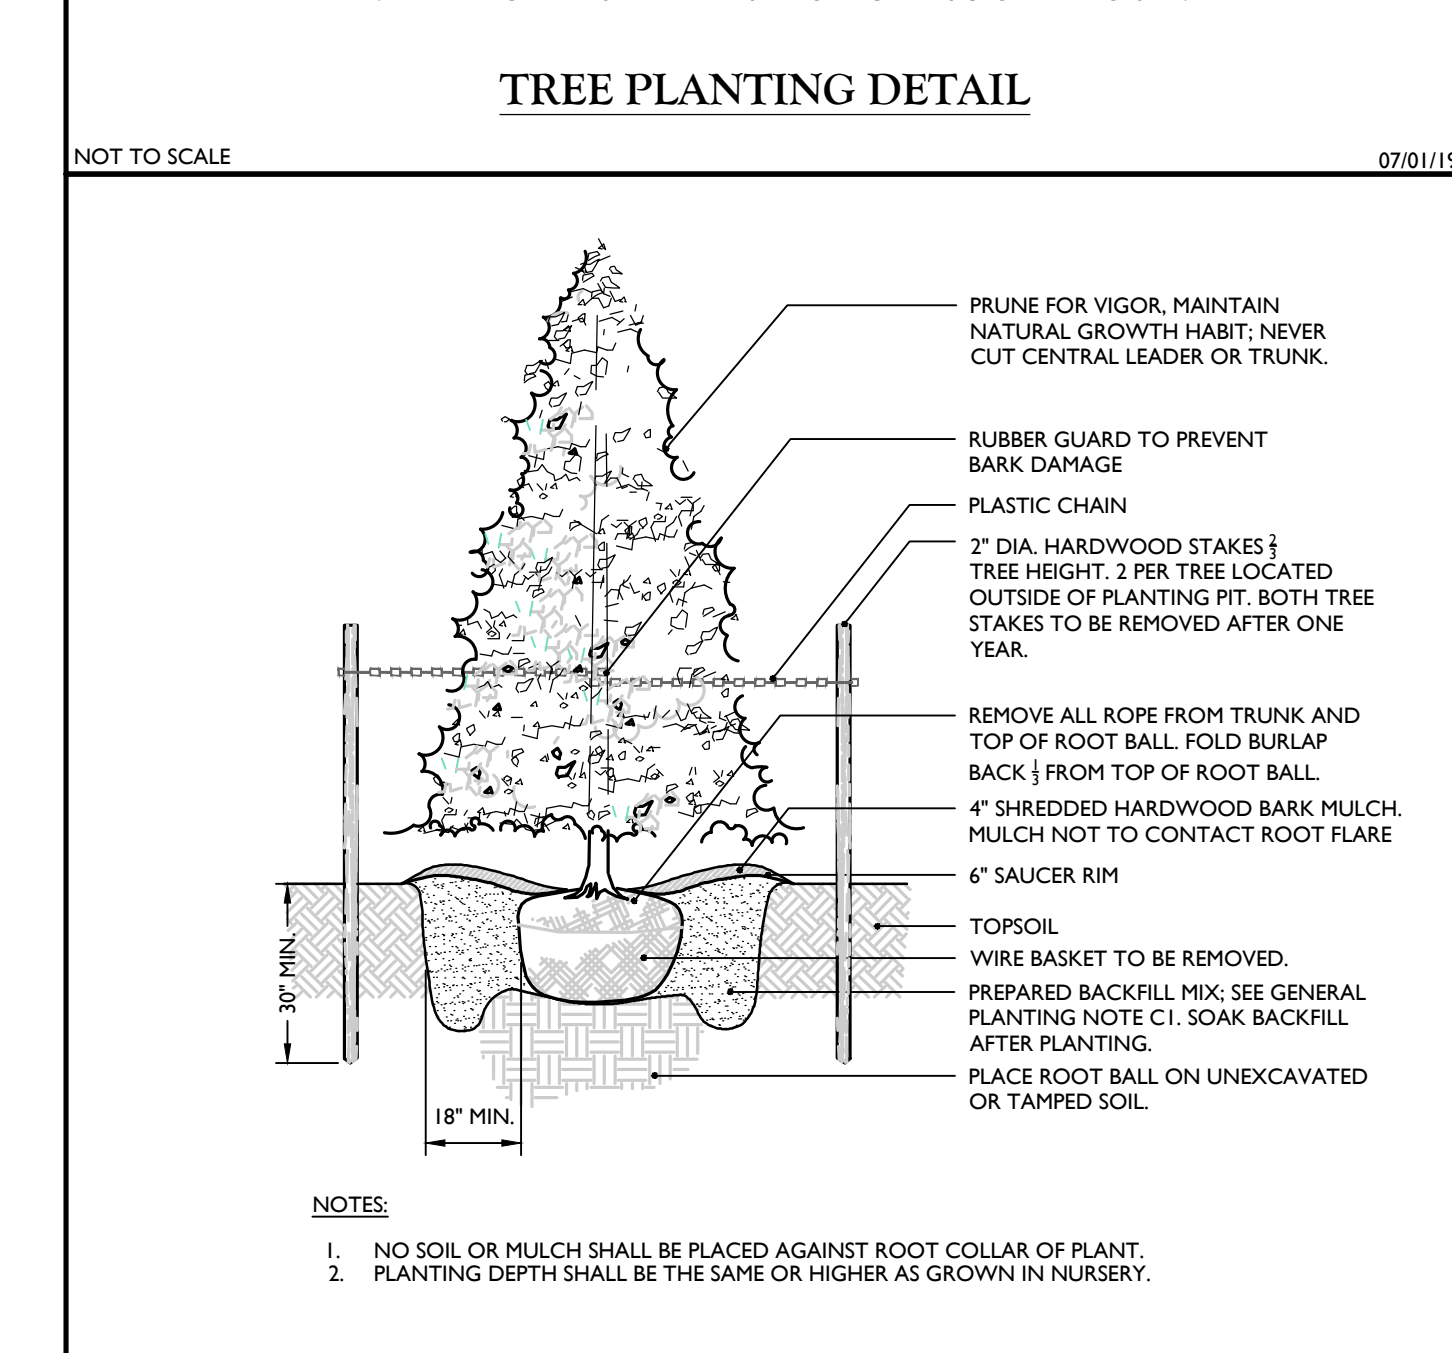
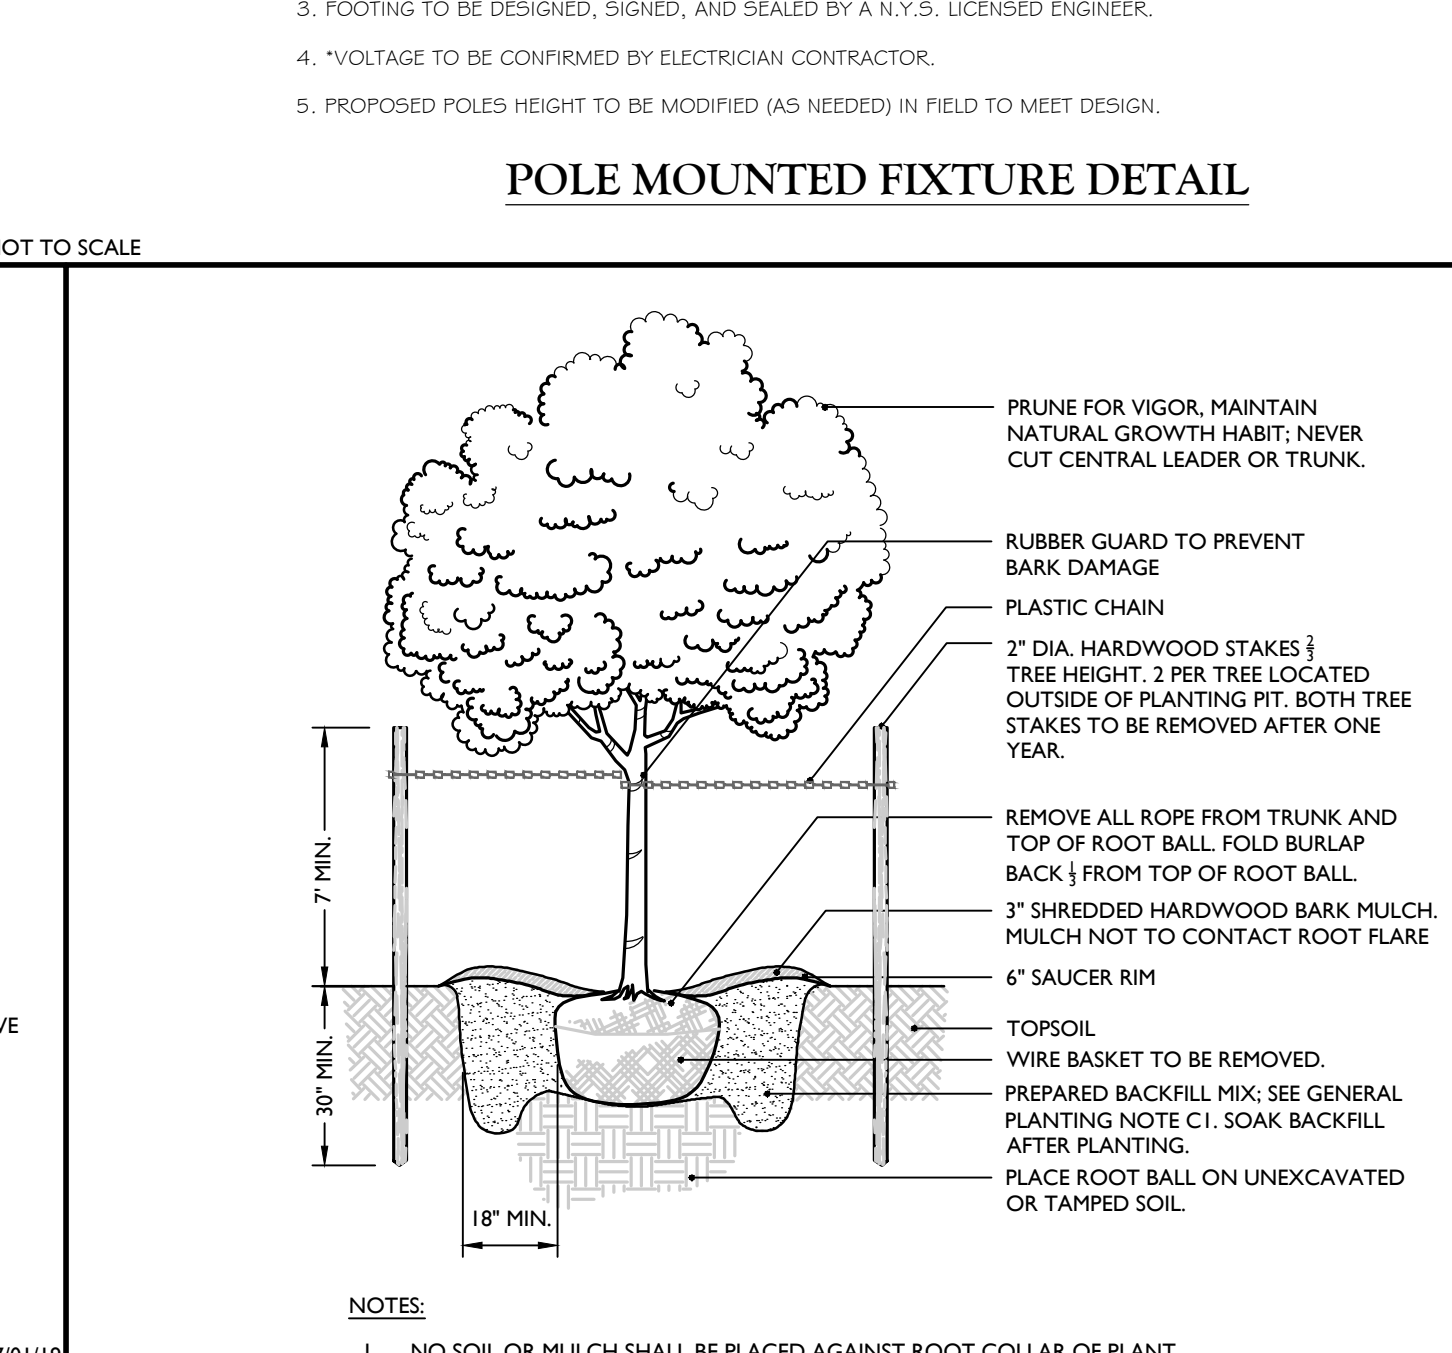
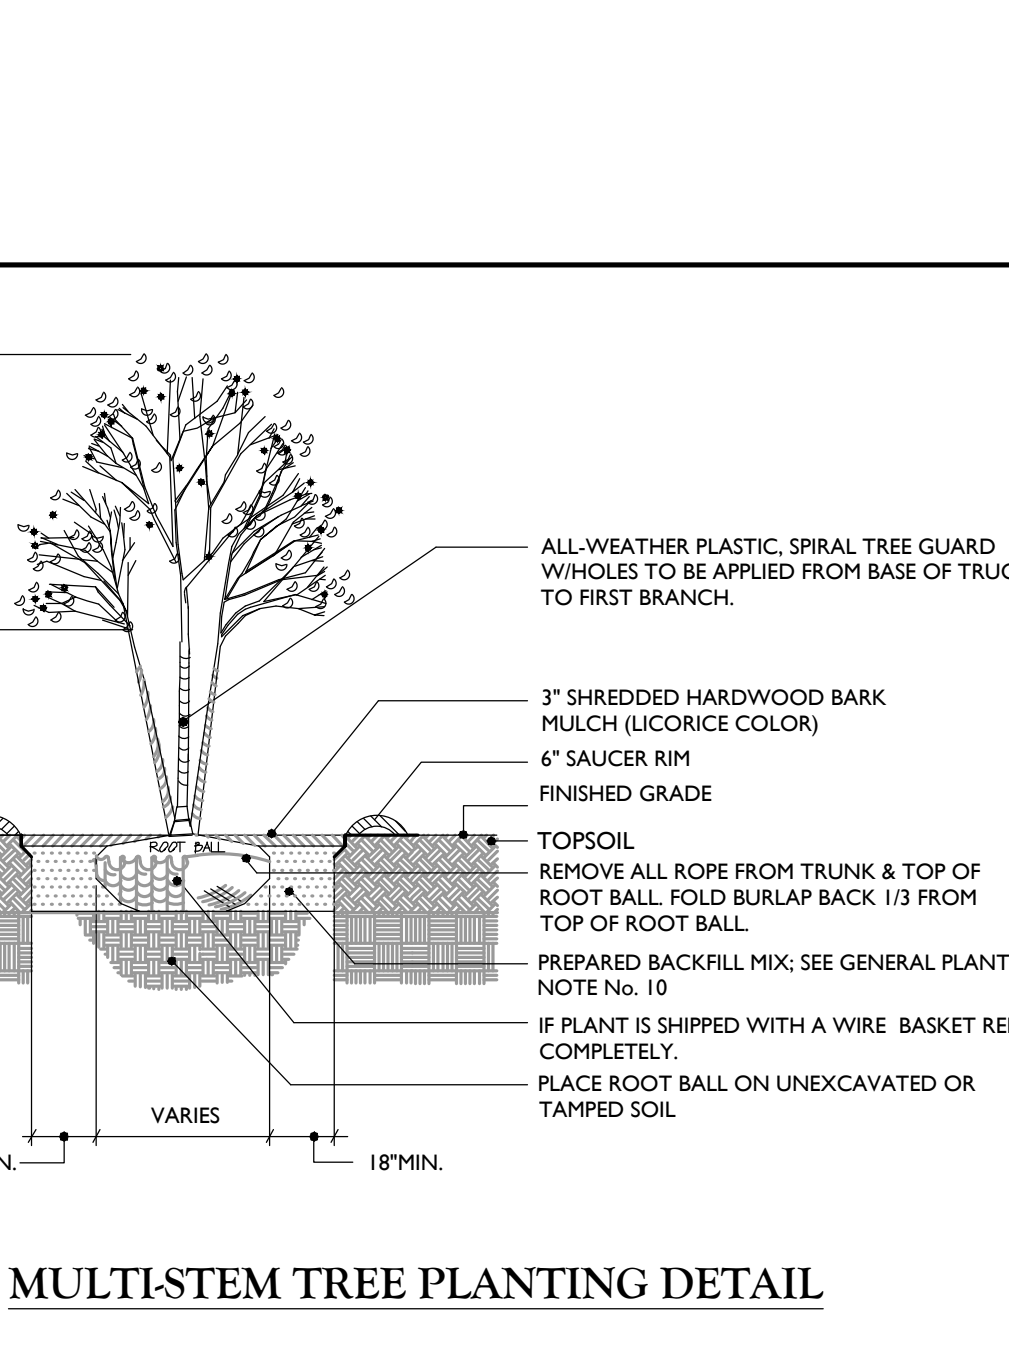
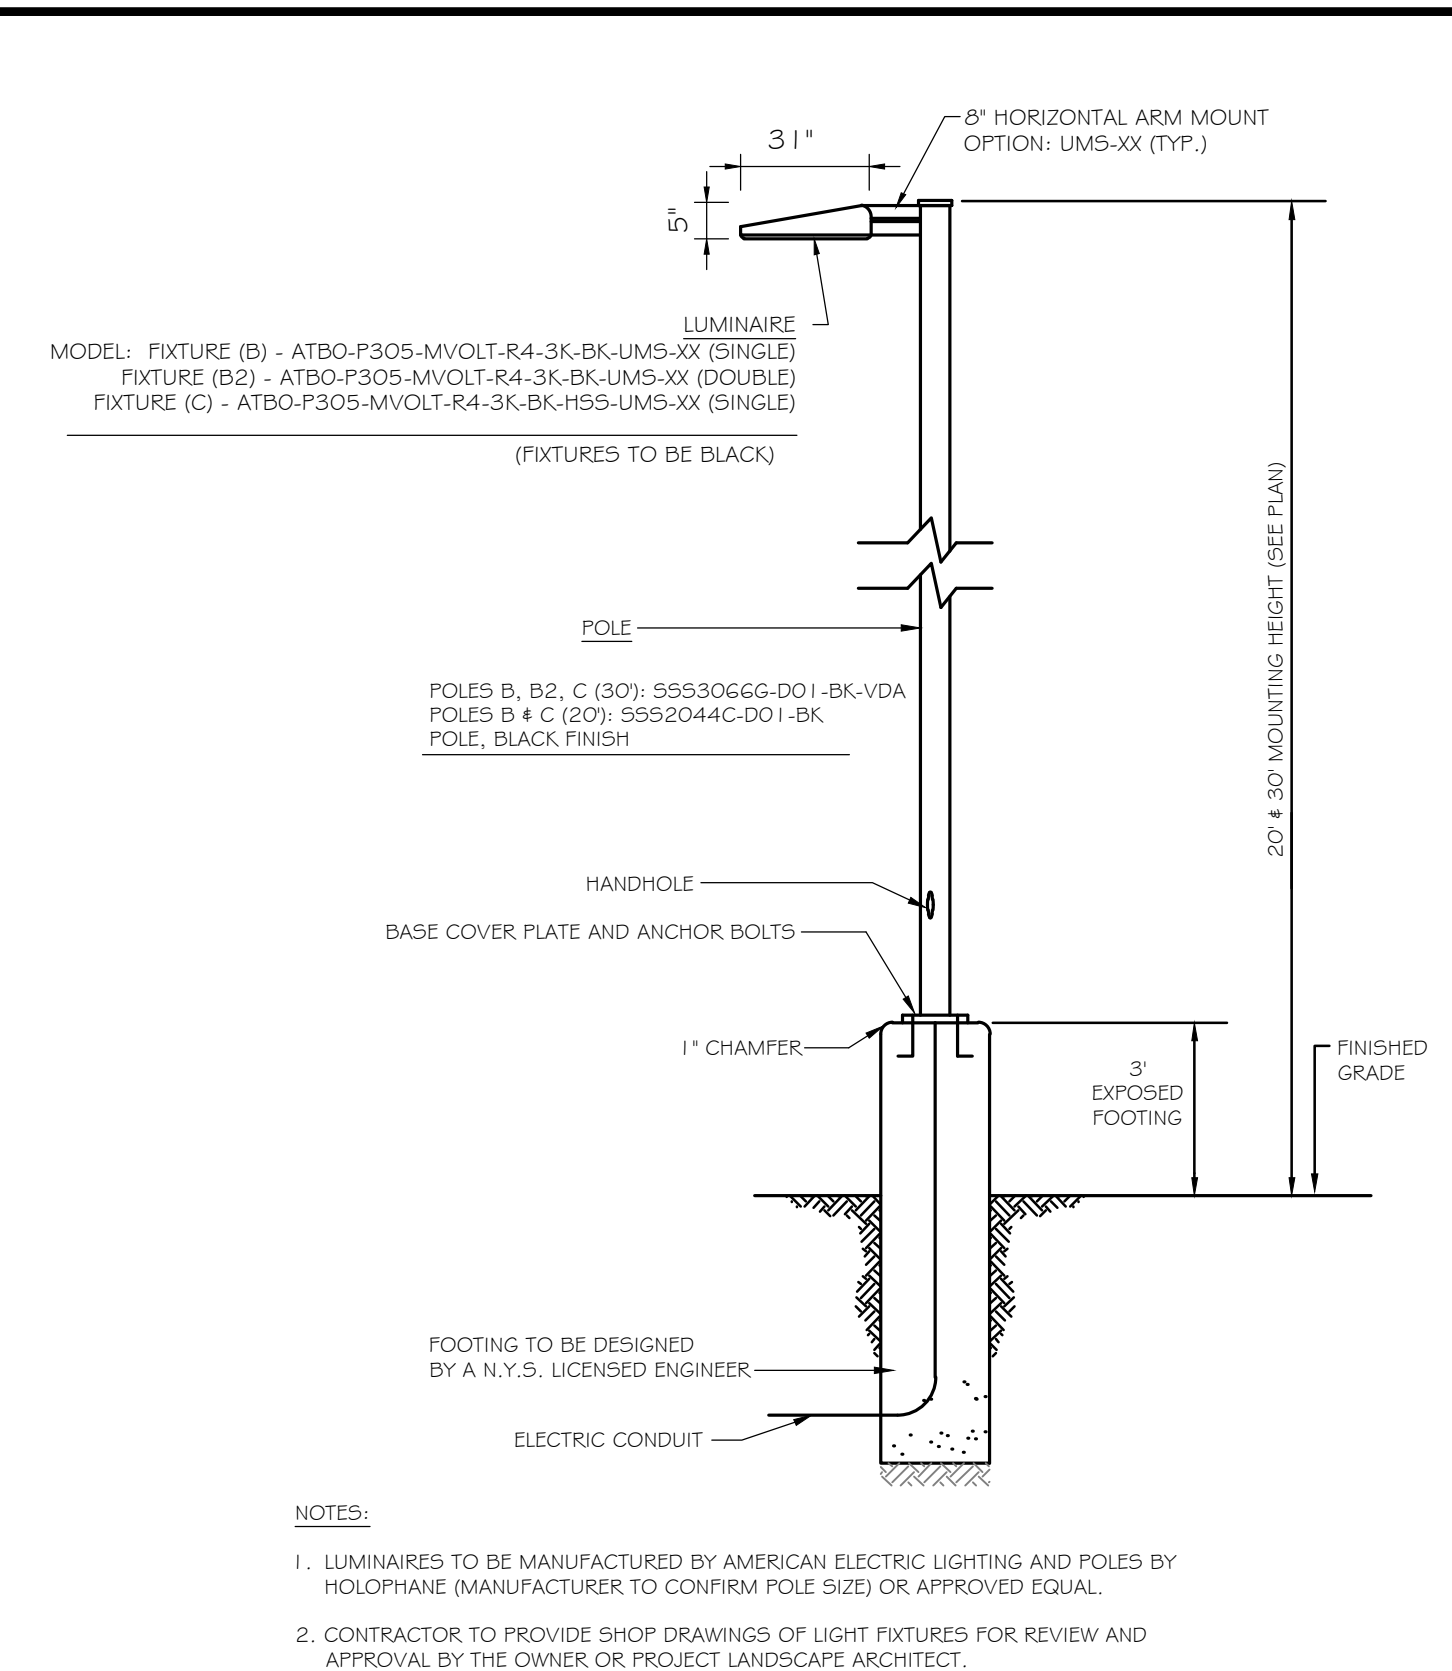
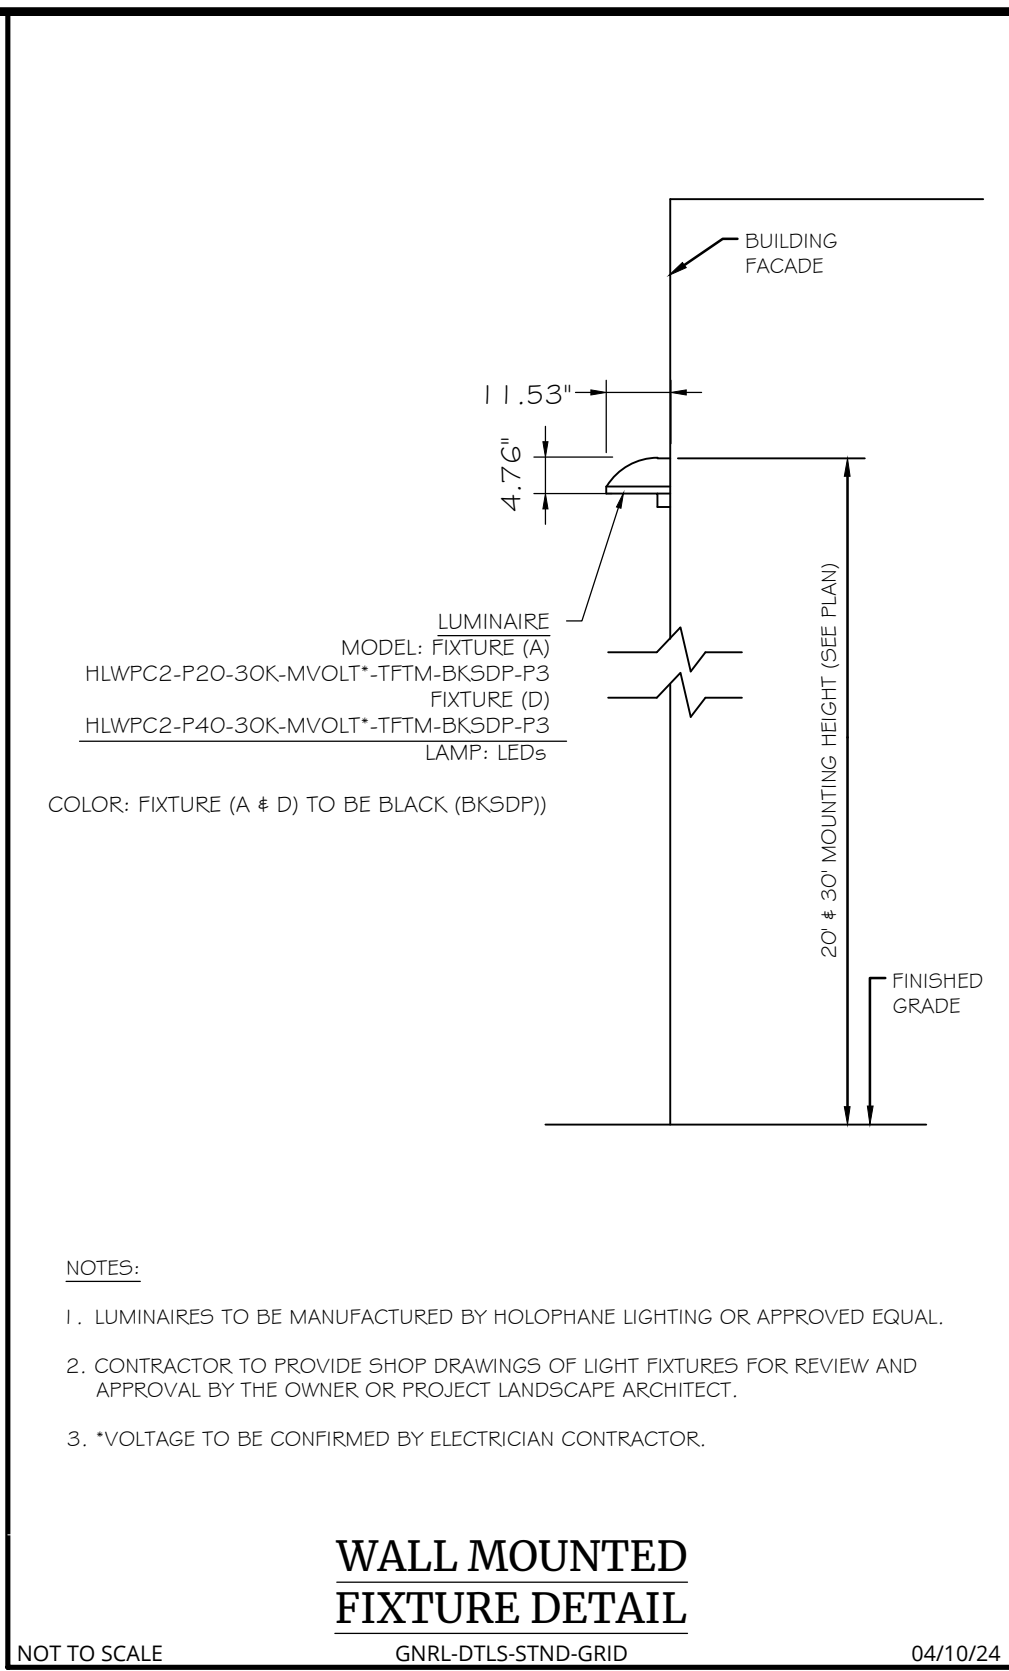
PRELIMINARY SITE PLAN FOR DEWPOINT SOUTH. SBL: 4-1-50.32, 6-1-90.22, 90.24 & 107. TOWN OF WAWAYANDA, ORANGE COUNTY, NEW YORK STATE.

NEWBURGH, 555 Hudson Valley Avenue, Suite 101, New Windsor, NY 12553. Phone: 845.564.4495. Colliers Engineering & Design, Inc. ARCHITECTURAL, ENGINEERING & SURVEYING, P.C.

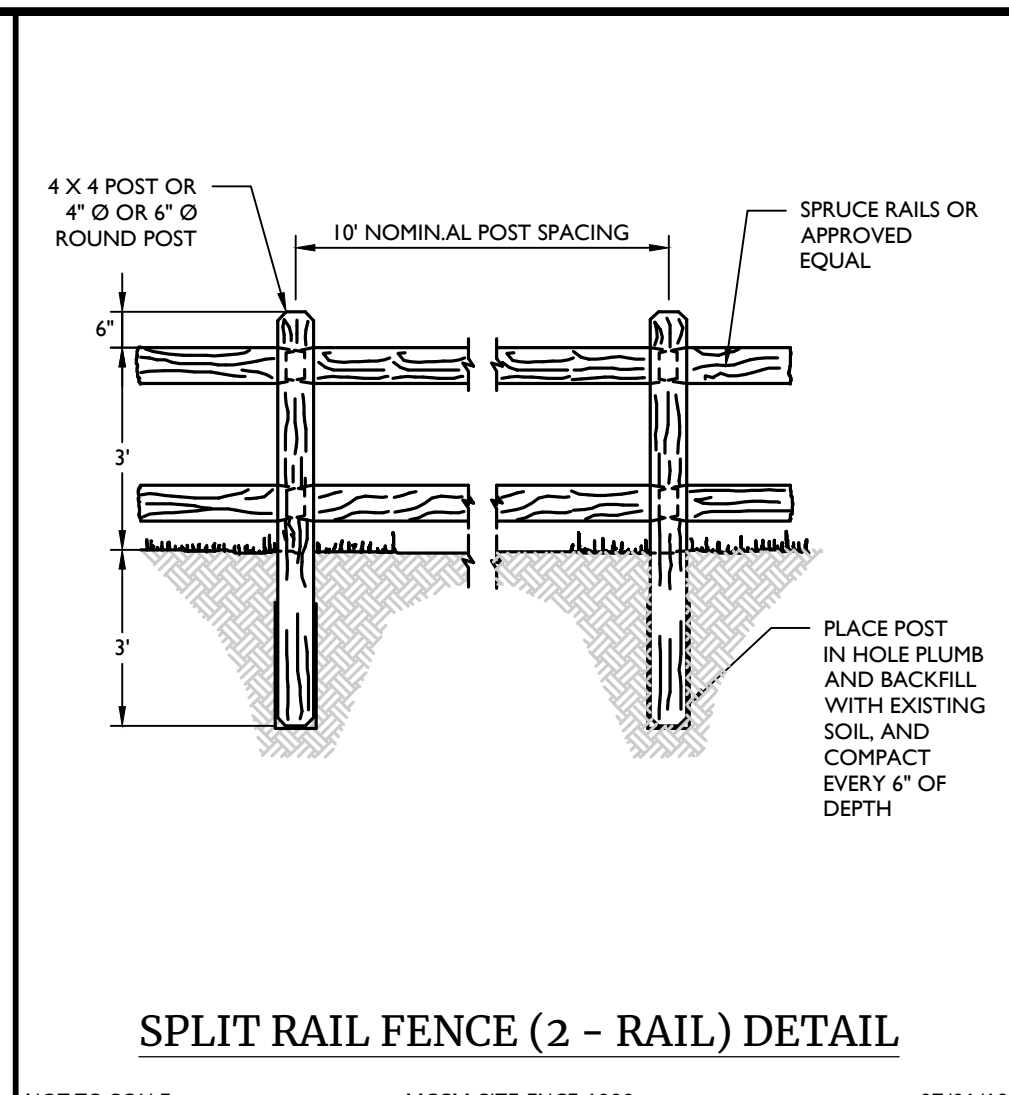AS SHOWN: 04/08/2024, MAM, CDR. PROJECT NUMBER: 20006912E, DRAWING NAME: C-0715. SHEET TITLE: SITE DETAILS. SHEET NUMBER: C-900.

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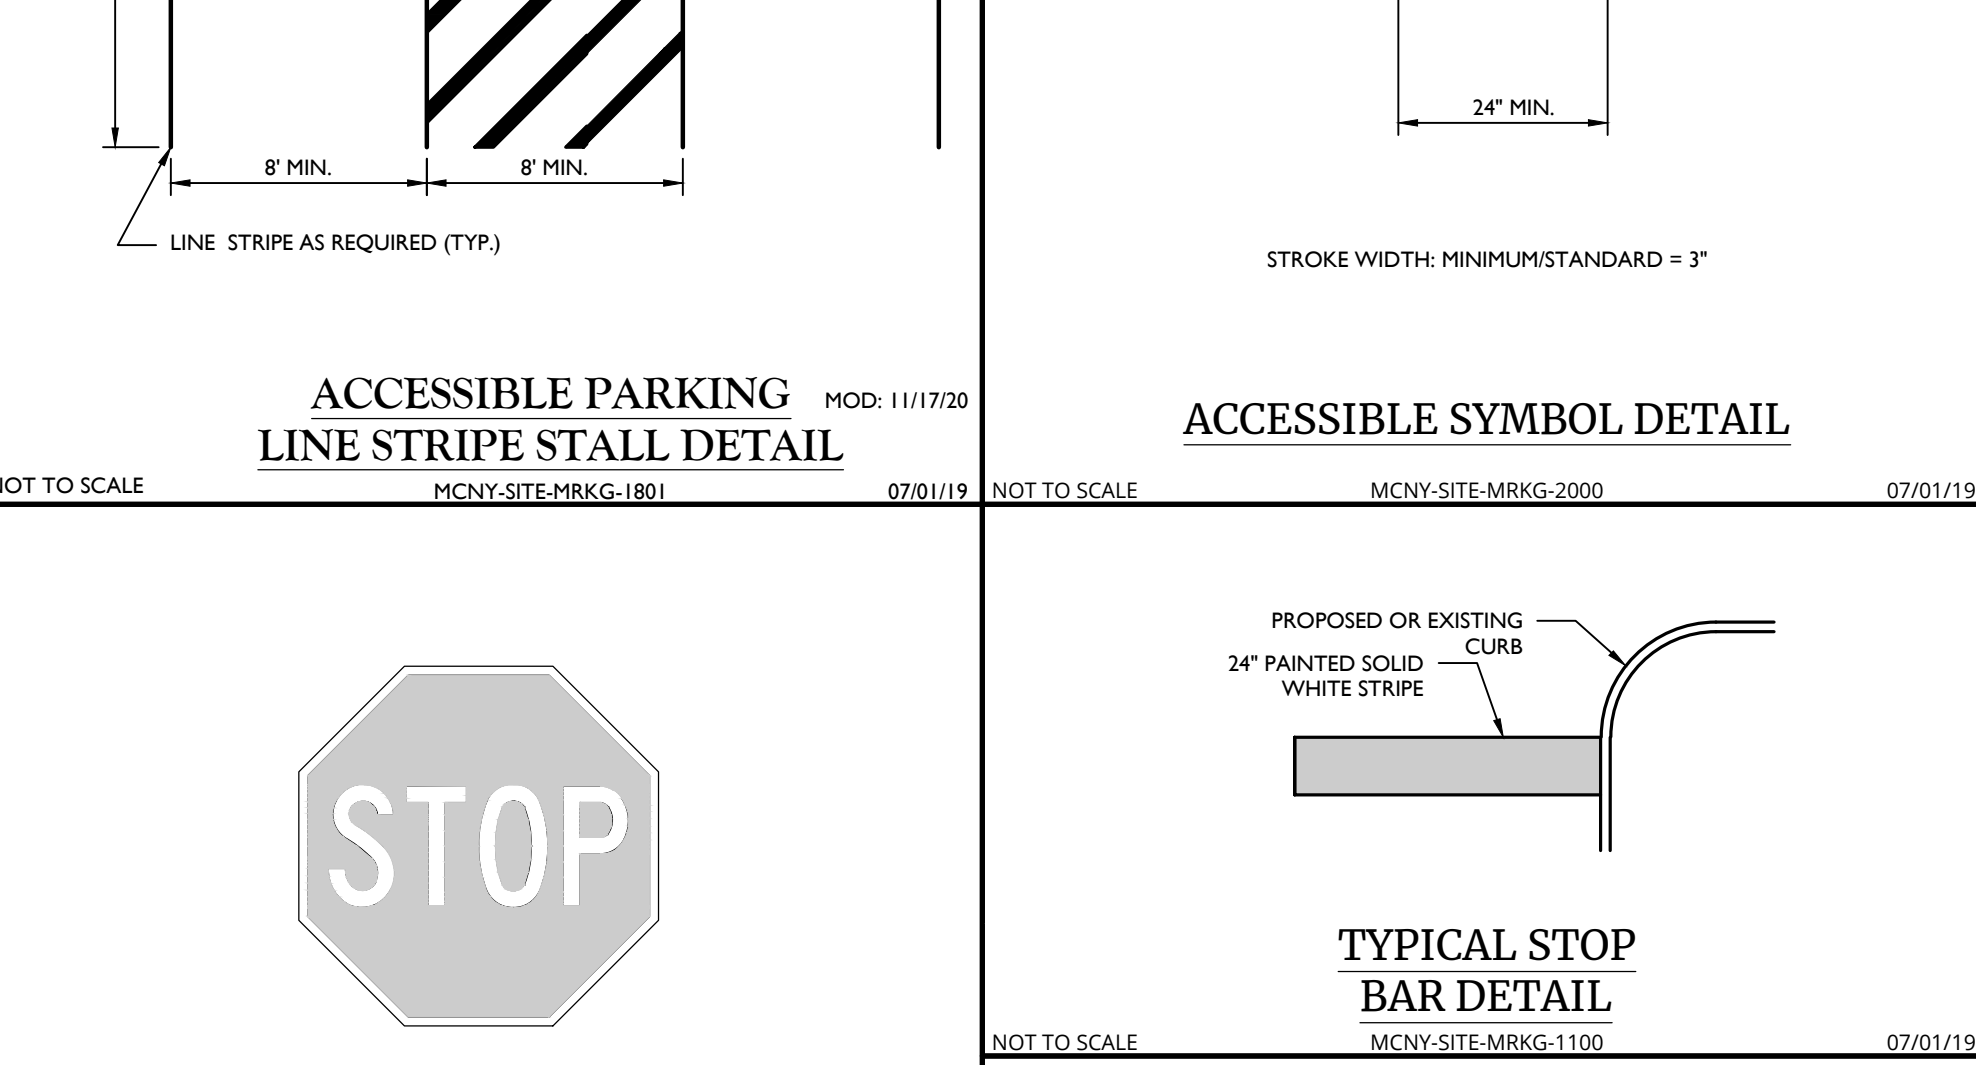
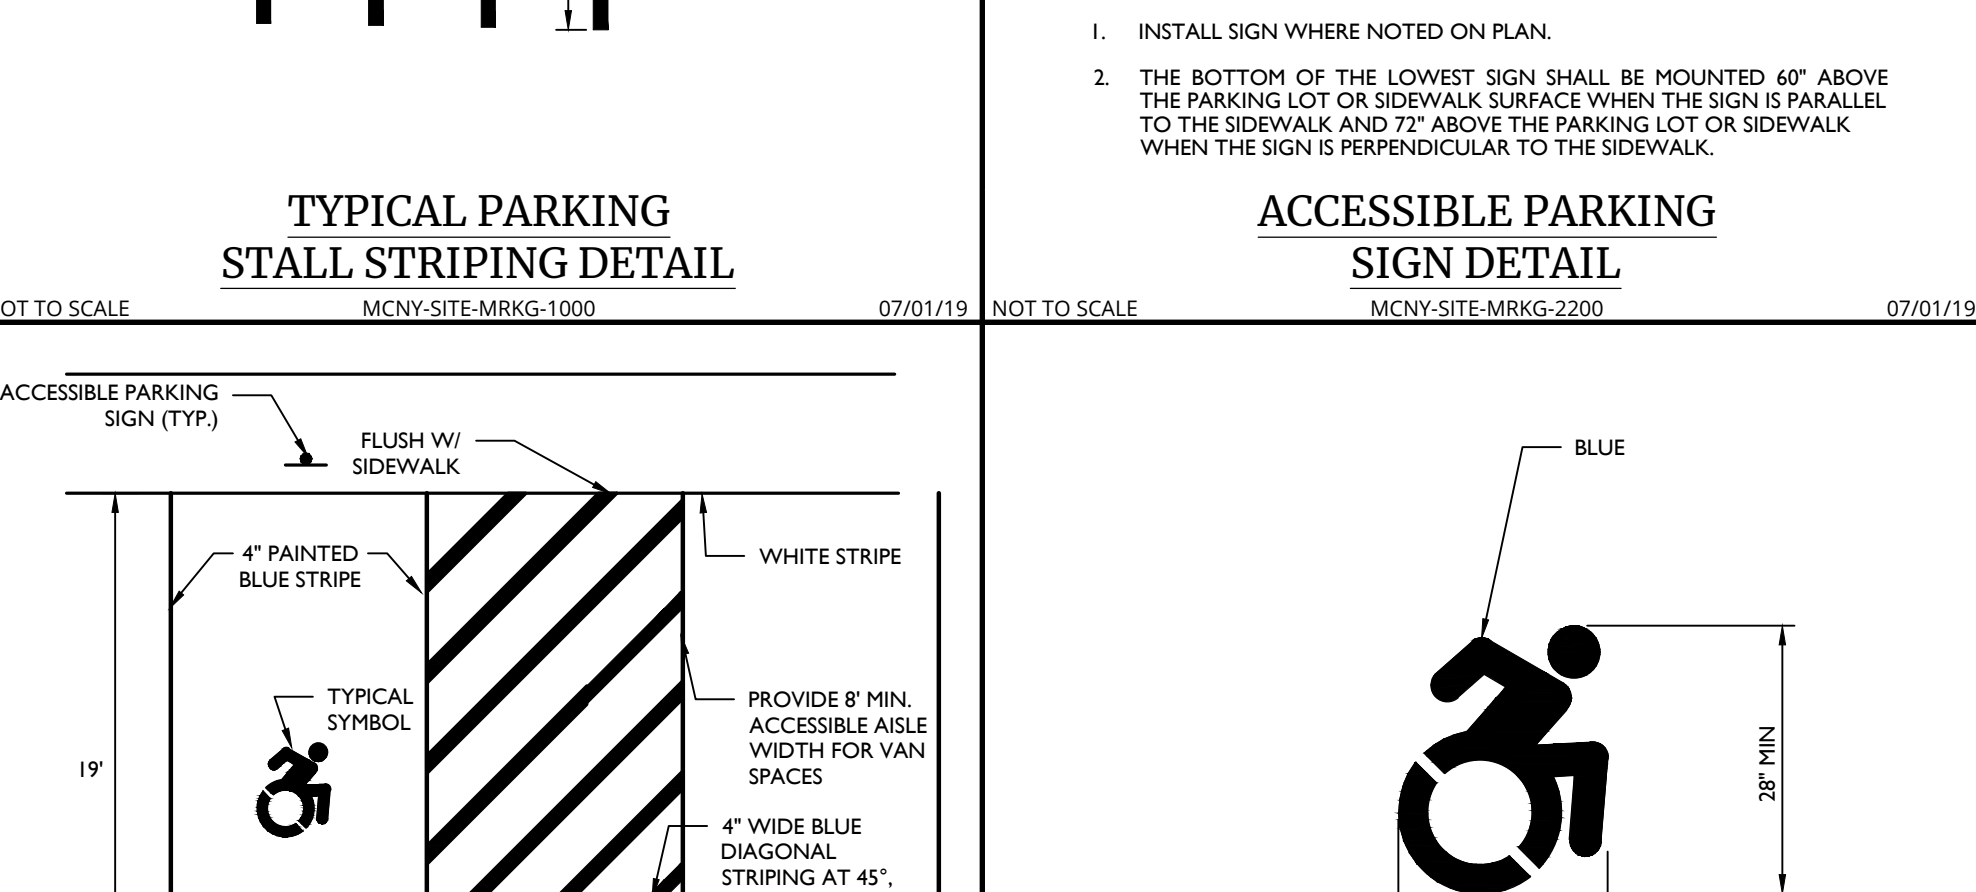
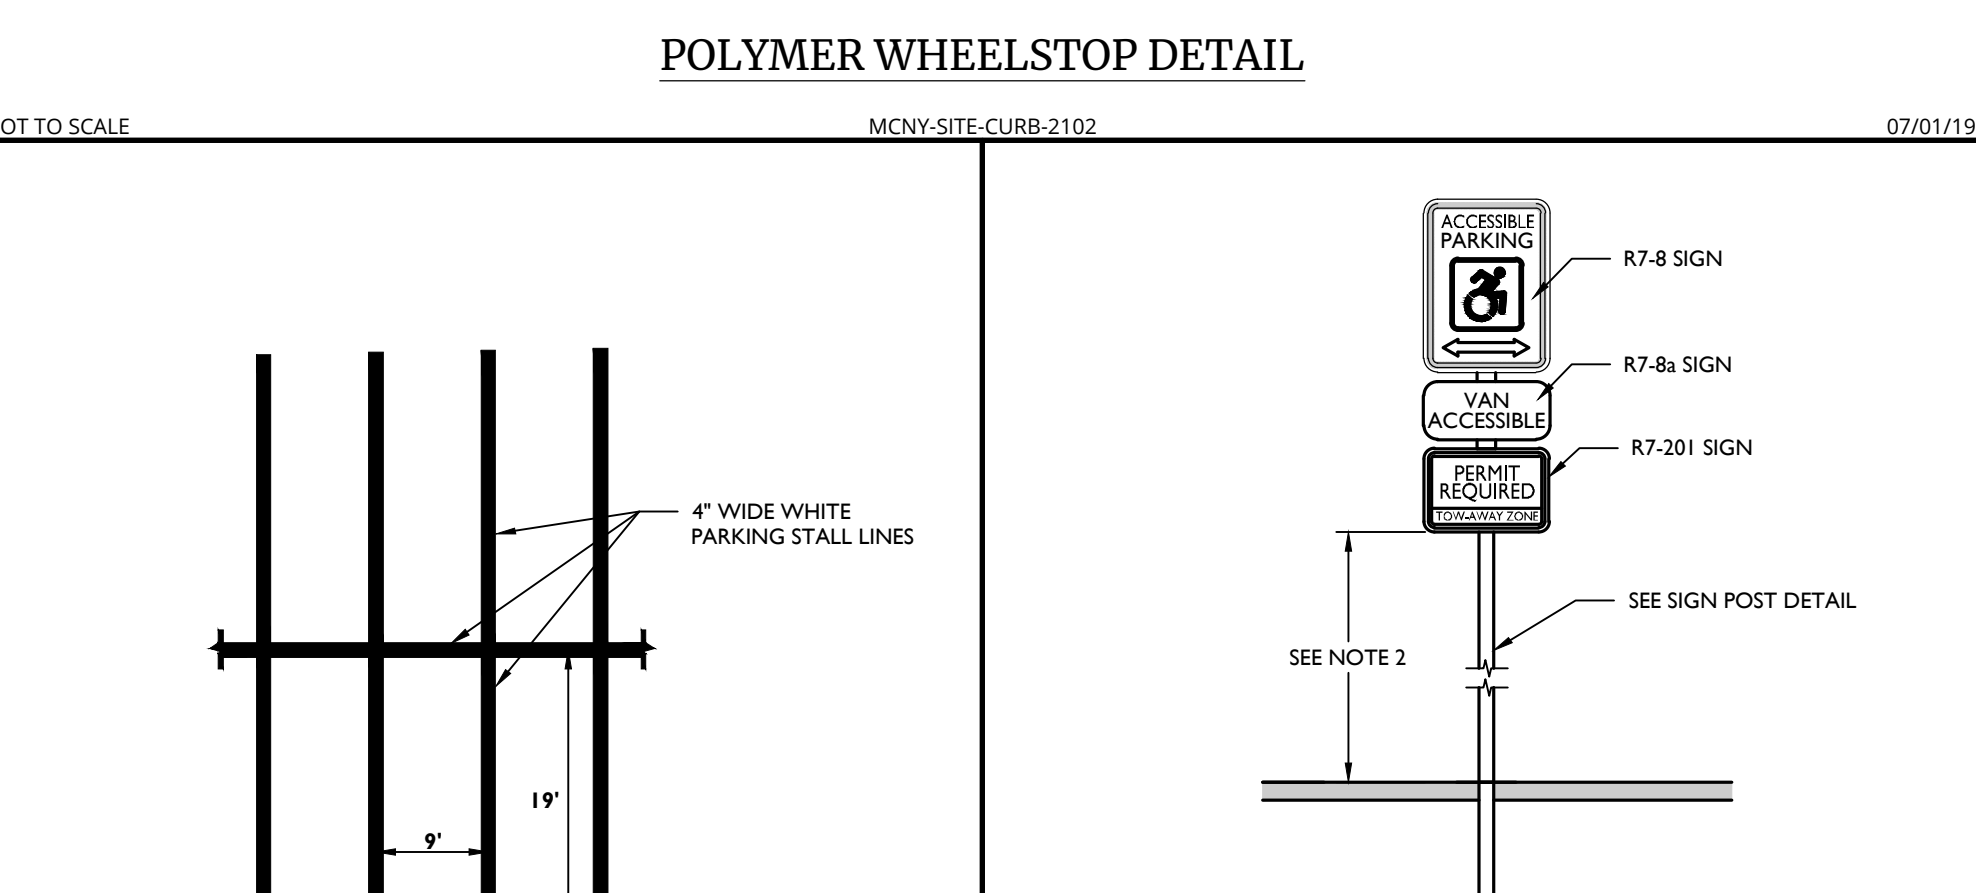
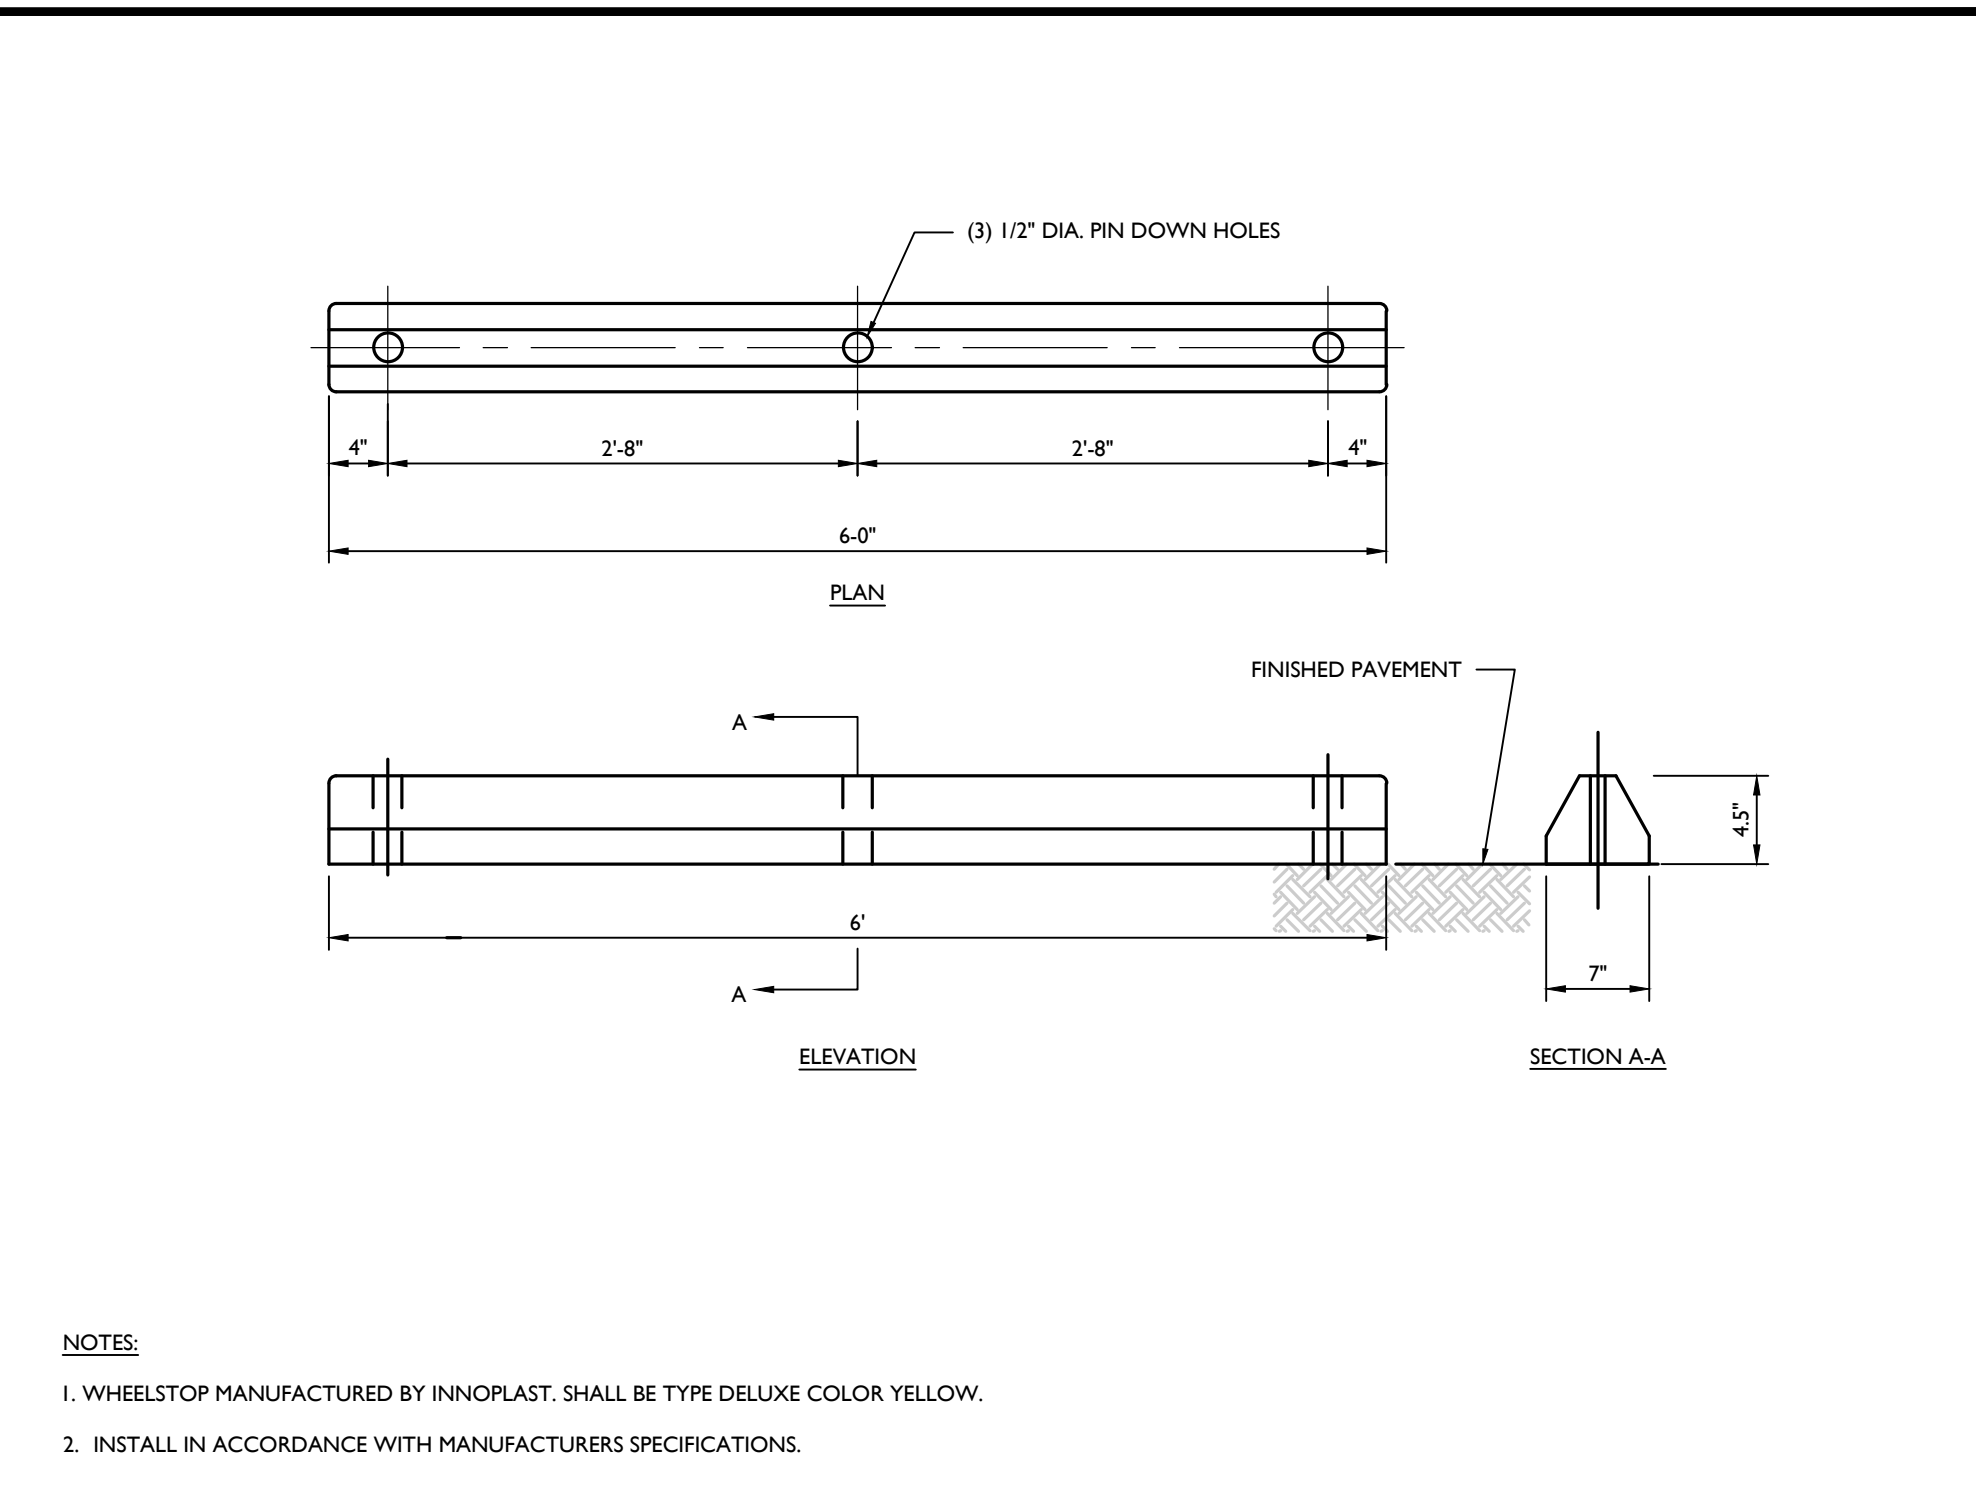
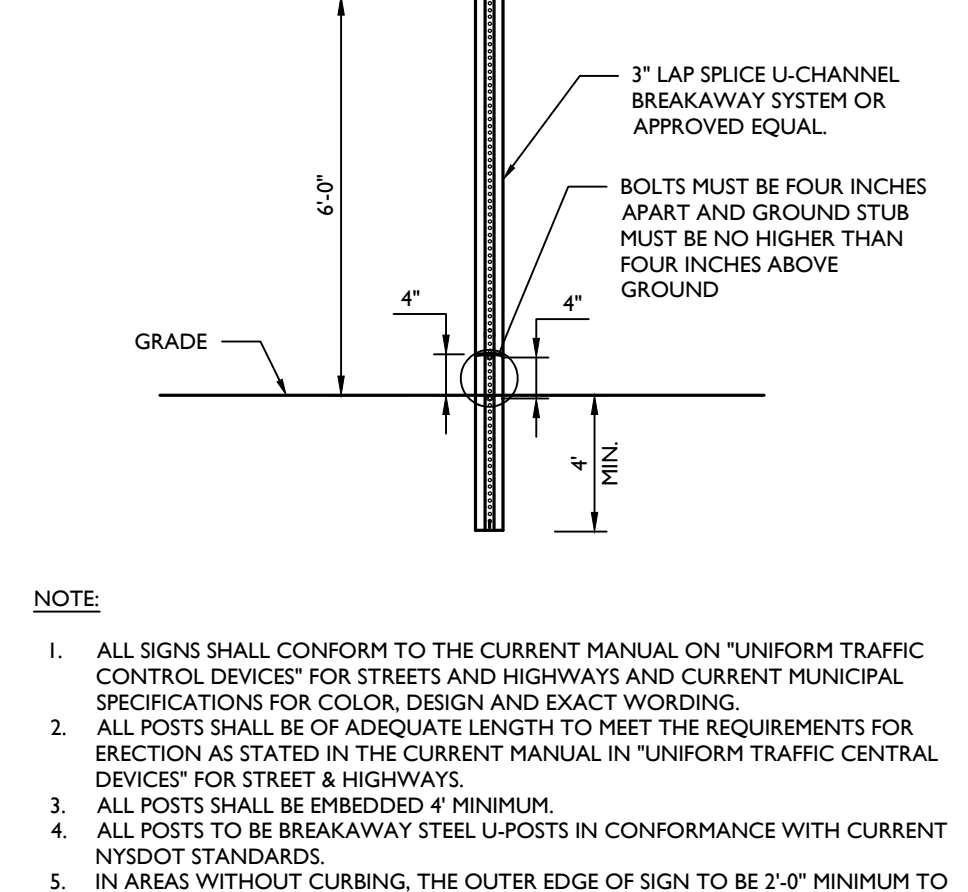
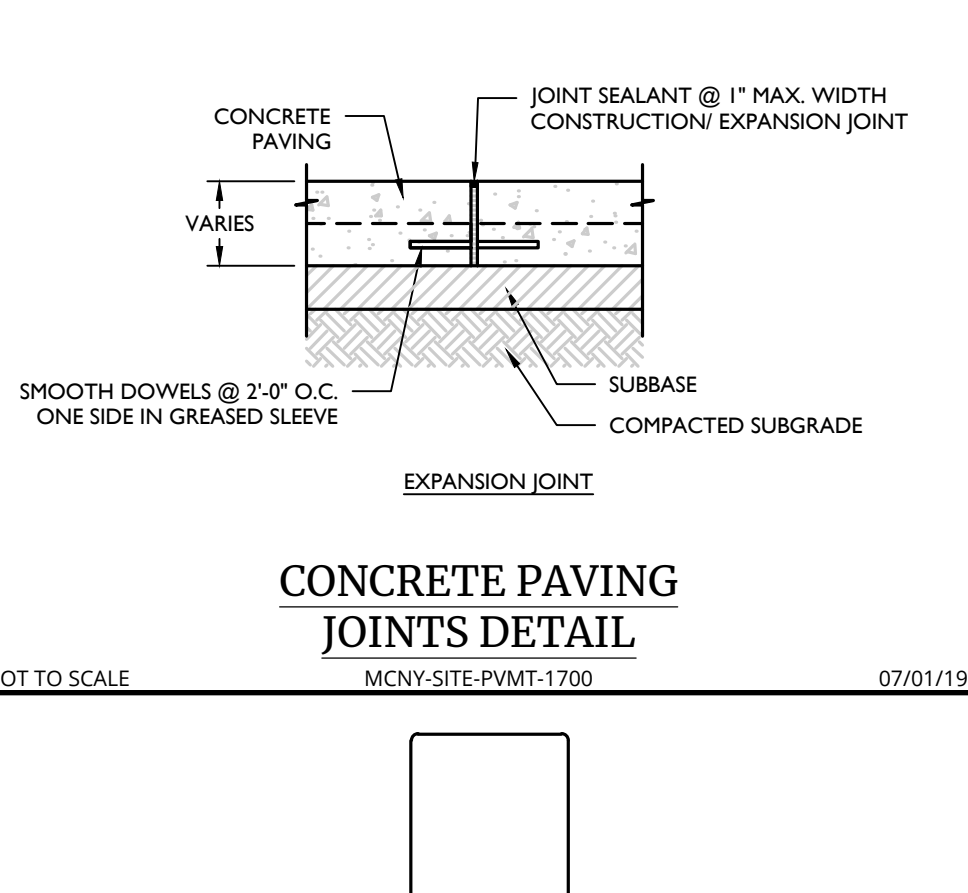
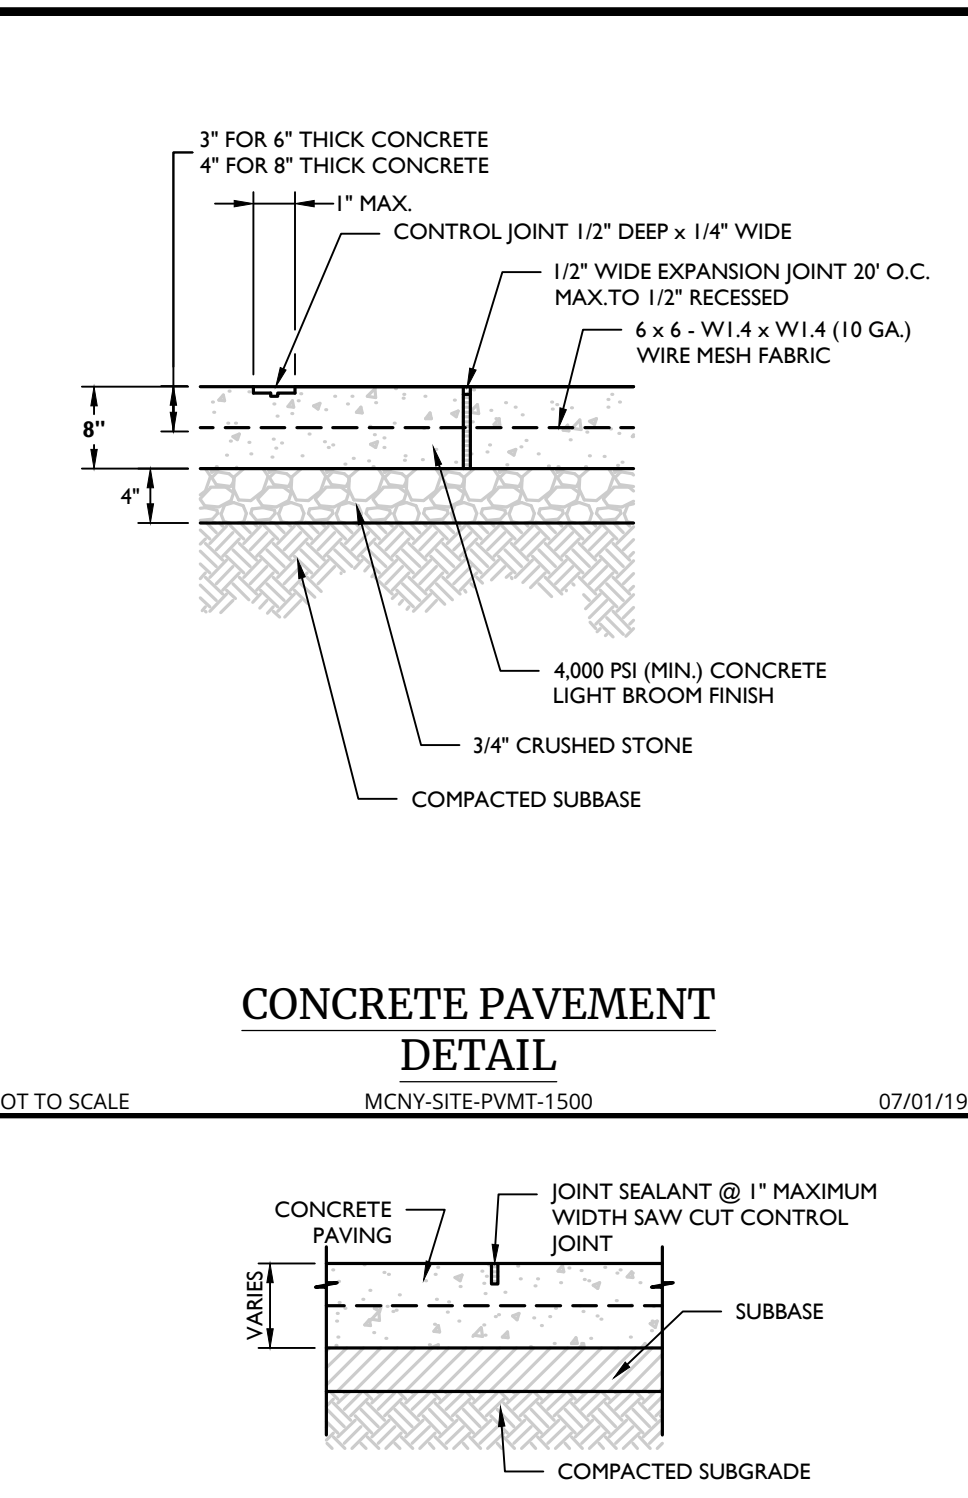
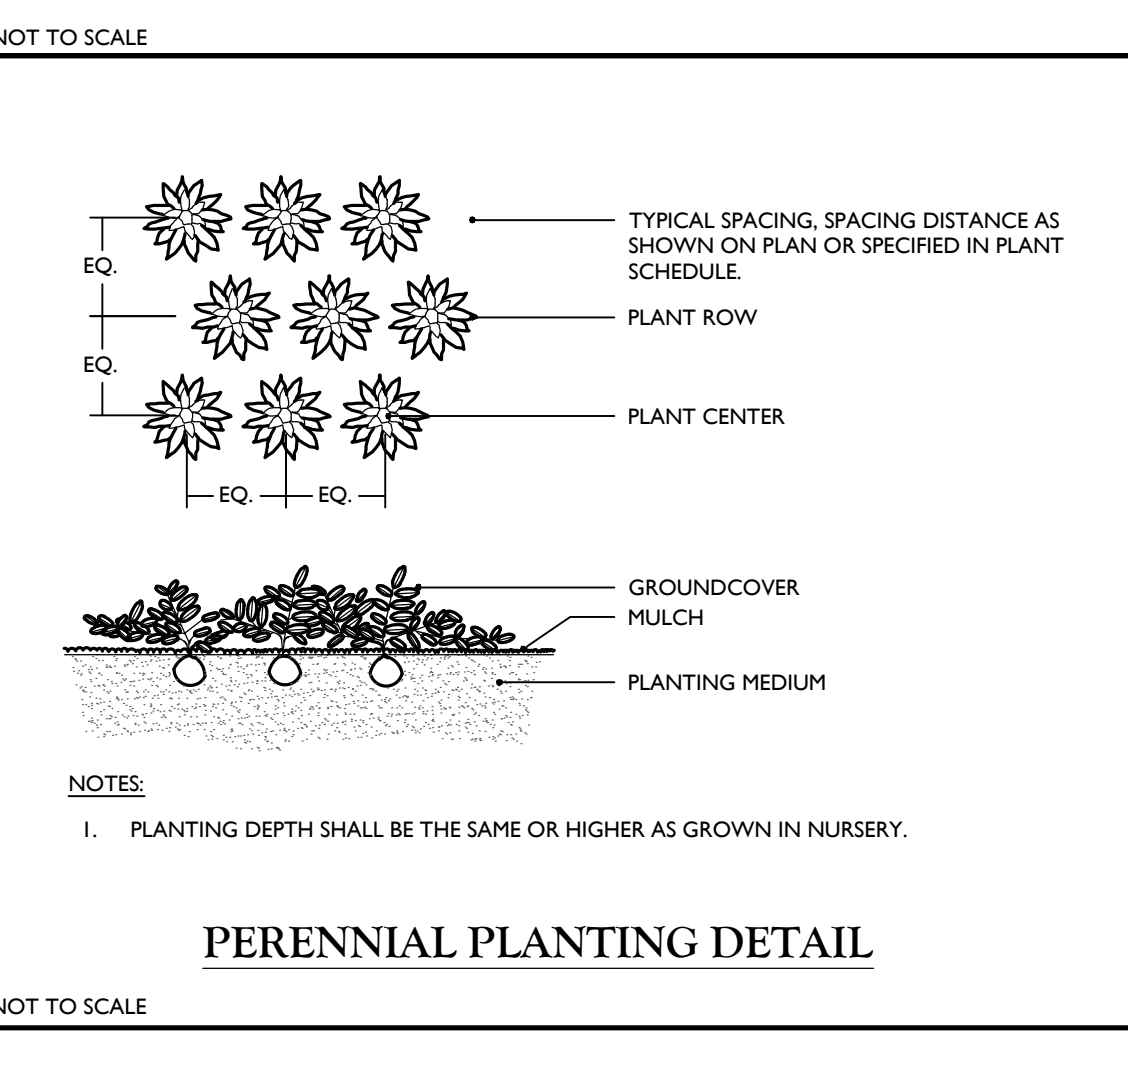
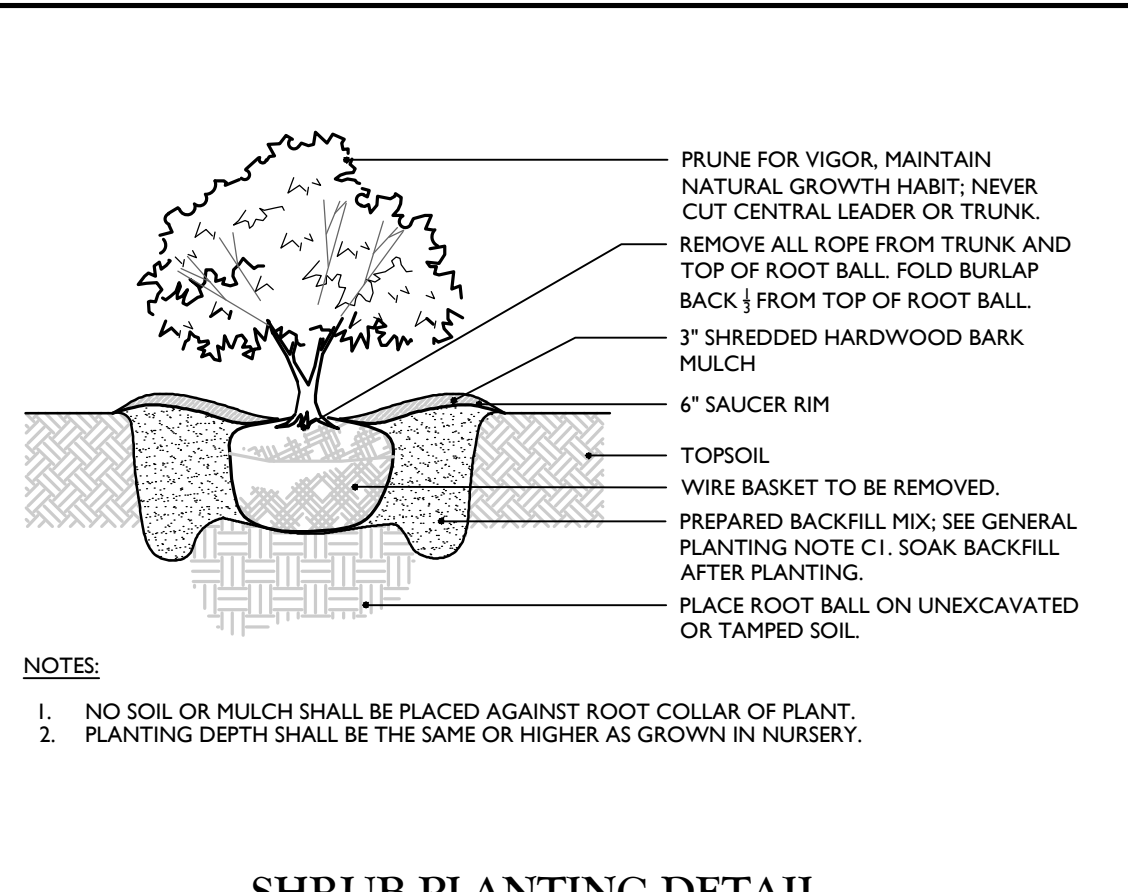


GENERAL SEEDING NOTES

1. TEMPORARY SEEDING: REFER TO SOIL EROSION AND SEDIMENT CONTROL PLANS.
2. PERMANENT SEEDING SHALL CONSIST OF THE FOLLOWING MIXTURE OR APPROVED EQUAL: OPTIMUM SEEDING DATES ARE BETWEEN APRIL 1 AND MAY 31; AND AUGUST 16 AND OCTOBER 15.
 TURF MIX (2.10 LBS./1,000 S.F. MINIMUM)
 TALL FESCUE STINGRAY (34%)
 TALL FESCUE RAFTOR II (33%)
 HARD FESCUE 'NOOY' (33%)
 BASIN MIX (2.10 LBS./1,000 S.F. MINIMUM)
 CREEPING RED FESCUE (30%)
 TALL FESCUE (30%)
 PERENNIAL RYE GRASS (10%)
 BIRDSFOOT TREFLOIL (30%)
3. SEEDING OUTSIDE OF THE OPTIMUM DATES SHALL NOT BE CONDUCTED WITHOUT PRIOR APPROVAL.
4. PERMANENT SEEDING TO BE APPLIED BY RAKING OR DRILLING INTO THE SOILS AT THE RATE GIVEN ABOVE.
5. FERTILIZER FOR THE ESTABLISHMENT OF TEMPORARY AND PERMANENT VEGETATIVE COVER SHALL BE IN COMPLIANCE WITH THE LATEST NYSDC REGULATIONS. THIS INCLUDES, BUT IS NOT LIMITED TO:
 1. NO FERTILIZER SHALL BE APPLIED BETWEEN DEC. 1 AND APRIL 1 IN ANY YEAR.
 2. SHALL NOT BE APPLIED WITHIN 20 FEET OF A WATER BODY.
 3. ONLY LAWN FERTILIZER WITH LESS THAN 0.67% BY WEIGHT PHOSPHATE CONTENT MAY BE APPLIED (A SOIL TEST PRIOR TO FERTILIZER APPLICATION IS RECOMMENDED.)
6. IF SEASON PREVENTS THE ESTABLISHMENT OF TEMPORARY OR PERMANENT SEEDING, EXPOSED AREA TO BE STABILIZED WITH MULCH AS INDICATED IN NOTE 6.
7. MULCH TO CONSIST OF SMALL GRASS STRAW OR SALT HAY ANCHORED WITH A WOOD AND FIBER MULCH BINDER OR AN APPROVED EQUAL. MULCH WILL BE SPREAD AT RATES PER NYSDC STANDARDS AND ANCHORED WITH A MULCH ANCHORING TOOL OR LIQUID MULCH BINDER, AND SHALL BE PROVIDED ON ALL SEEDINGS. HYDROMULCH SHALL ONLY BE USED DURING OPTIMUM GROWING SEASONS.
8. AS NEEDED, WORK LIME AND FERTILIZER INTO SOIL AS NEARLY AS PRACTICAL TO A DEPTH OF 4 INCHES WITH A DISC, SPRINGTOOTH HARROW, OR OTHER SUITABLE EQUIPMENT. THE FINAL HARROWING OR DISCING OPERATION SHOULD BE ON THE GENERAL CONTOUR. CONTINUE TILLAGE UNTIL A REASONABLY UNIFORM, FINE SEEDBED IS PREPARED. ALL BUT CLAY OR SILTY SOILS AND COARSE SANDS SHOULD BE ROLLED TO FIRM THE SEEDBED WHENEVER FEASIBLE.
9. REMOVE FROM THE SURFACE ALL STONES TWO INCHES OR LARGER IN ANY DIMENSION. REMOVE ALL OTHER DEBRIS, SUCH AS WIRE, CABLE, TREE ROOTS, PIECES OF CONCRETE, CLODS, LUMPS, OR OTHER UNSUITABLE MATERIAL.
10. INSPECT SEEDBED JUST BEFORE SEEDING. IF TRAFFIC HAS LEFT THE SOIL COMPACTED, THE AREA MUST BE RETILLED AND FIRMED AS ABOVE.

PLANT DETAIL NOTES

1. NO SOIL OR MULCH SHALL BE PLACED AGAINST ROOT COLLAR OF PLANT. MULCH SHALL NOT TOUCH THE TREE TRUNK.
2. PLANTING DEPTH SHALL BE THE SAME OR HIGHER AS GROWN IN NURSERY.
3. WIRE BASKETS AND NON-JUTE BURLAP MUST BE ENTIRELY REMOVED FROM THE ROOT BALL. JUTE BURLAP MUST BE REMOVED FROM THE TOP 1/3 OF THE ROOT BALL.
4. DEPTH OF PLANT PIT SHALL BE INCREASED BY 1/2" WHEREVER POOR SOIL CONDITIONS OCCUR, WITH THE ADDITION OF LOOSE AGGREGATE.
5. CONTRACTOR SHALL PARTIALLY FILL WITH WATER A REPRESENTATIVE NUMBER OF PITS IN EACH AREA OF THE PROJECT PRIOR TO PLANTING TO DETERMINE IF THERE IS ADEQUATE PERCOLATION. IF PIT DOESN'T PERCOLATE, MEASURES MUST BE TAKEN TO ASSURE PROPER DRAINAGE BEFORE PLANTING.
6. PLANTING MUST BE GUARANTEED FOR TWO FULL GROWING SEASONS FROM THE TIME OF FINAL ACCEPTANCE BY THE LANDSCAPE CONSULTANT. CONTRACTOR SHALL REMOVE ALL WRAPPING AT THE END OF GUARANTEE PERIOD OR SOONER PER PROJECT LANDSCAPE ARCHITECT.
7. BACKFILL MIXTURE TO BE SPECIFIED BASED UPON SOIL TEST AND CULTURAL REQUIREMENTS OF PLANT.
8. PRUNE DAMAGED AND CONFLICTING BRANCHES MAINTAINING NORMAL TREE SHAPE, NEVER CUT CENTRAL TRUNK OR LEADER.



| REV | DATE | DESCRIPTION | DRAWN BY | DATE | DESCRIPTION |
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| 1 | 04/10/24 | REVISED PER BUILDING DEPT. | AS SHOWN | 04/08/2024 | MAS |
| 2 | | | PROJECT NUMBER: | 20006912E | DRAWING NAME: C-0115 |
| SHEET TITLE: SITE DETAILS | | | | | |
| SHEET NUMBER: C-901 | | | | | |

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Robinson Cory Daniel
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 LICENSE NUMBER: 103788-01
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PRELIMINARY SITE PLAN FOR DEWPOINT SOUTH
 SBL: 4-1-50.32, 6-1-90.22, 90.24 & 107
 TOWN OF WAWAYANDA ORANGE COUNTY NEW YORK STATE

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SCALE: AS SHOWN DATE: 04/08/2024 DRAWN BY: MAS CHECKED BY: CDR
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